A/C

ALT.

ABOVE FINISHED FLOOR ACCESS PANEL **ACOUST** ACOUSTIC (AL) ADD. ADDENDA (ADDENDUM) ADJUSTABLE, ADJACENT AGGREGATE AIR CONDITIONING ALTERNATE ALUMINUM **AMOUNT** ANCHOR BOLT ANGLE

AMT. APPROX. APPROXIMATE (LY) ARCHITECT (URAL) A.D. AREA DRAIN, ACCESS DOOR ASPH. AVG. AVERAGE B/B BACK TO BACK BASEMENT B.PL. BASE PLATE BEARING BENCHMARK

BM. BRG. B/M BTWN. BETWEEN BLK.(G BLOCK (ING) B.C. BOTTOM OF CURB ELEVATION B.S. BOTTOM OF STEP ELEVATION B.W. BOTTOM OF WALL BRDG. BRIDGING BLDG. BUILDING BUILT-UP ROOF CAB. CABINET CLKG. CALKING, CAULKING CPT. CAST IRON C.I.P. CAST-IN- PLACE CATCH BASIN CATEGORY CENTER TO CENTER Y CER. CENTER LINE

CERAMIC

C.T.

CLR

CLO. COL.

CONT.

CRS.

C.C.J.

CU. D.L. DK.

DEF.

DEPT

DET.

DIAG.

DIA.

DIM.

DR.

DBL.

DN. D.S.

DWR.

DWG.

D.F.

EA.

E.E.

E.S.

E.W.

ELEC.

E.C.

E.W.C.

ELEY.

ENCL.

EQ.(=)

EQUIP.

EXP. JT.

EXT.

FT. (')

FEET (FOOT)

FIELD WELD

FIRE EXTINGUISHER

FIRE HOSE CABINET

FIRE EXTINGUISHER CABINET

FINISHED FLOOR ELEVATION

FIRE RETARDANT TREATED

FIRE RATED GYPSUM WALL BOARD

FINISH (ED)

FIXTURE

FOOTING

FRESH AIR

FURRING

FUTURE

GENERAL

GRADE

GROUND

GYPSUM

FLOOR DRAIN

FLOOR (ING)

FLUORESCENT

FOUNDATION

GALYANIZED

GAUGE, GAGE

GRADE BEAM

GENERAL CONTRACTOR

GYPSUM WALL BOARD

GENERAL TRADE CONTRACTOR

F.S.

FIN.

F.E.

F.E.C.

F.F.E.

FIXT.

F.D.

FLUOR

FTG. FDN.

F/A

FUT.

GA.

GEN.

G.T.C.

G.C.

GL.

GR.

G.B.

GND.

GYP.

FURR.

GALY

F.R.G.W.B.

CERAMIC TILE CHALKBOARD CLOSET COLUMN COORD. COORDINATE COMPACTED GRANULAR BASE COMP. COMPOSITE CONCRETE MASONRY UNIT CONC. CONCRETE COND. CONDITION CONDUIT CONNECTION CONST. CONSTRUCT (ION) CONTINUOUS CONTR CONTRACT (OR) CONTROL JOINT CONTROLLED DENSITY FILL CORNER GUARD CORRIDOR CORRUGATED COUNTERSINK COURSES CRACK CONTROL JOINT CUBIC, COPPER DEAD LOAD DECK DEFORMED

PR, DEPARTMENT P.L.F. DETAIL PERF. DIAGONAL PERIM. DIAMETER P.S.I. DIMENSION PLAS. DOOR DOUBLE PL. LAM. PLASTIC LAMINATE DOWN DOWN SPOUT PLBG. DRAWER PLWD. DRAWING DRINKING FOUNTAIN PRCST. EACH P.C.C. EACH END PREFIN. EACH SIDE EACH WAY QTY. ELECTRIC (AL) ELECTRICAL CONTRACTOR ELECTRIC WATER COOLER ELEVATION (HEIGHT) REINF. ENCLOSURE REQ'D EQUAL RES. EQUIPMENT R.A. EXIST./EX. EXISTING REY. EXPANDED POLYSTYRENE EXPANSION EXPANSION JOINT R/WR.D. EXTERIOR FAR SIDE

HANDICAP, HOLLOW CORE HARDWARE HEATING HEATING, VENTILATING & AIR CONDITIONING HIGH POINT HIGH STRENGTH HOLLOW METAL HOOKED HORIZONTAL HOSE BIBB INCH (ES) INCLUDE (D) INSIDE DIAMETER INSULATION I.R.D.S. INTERGAL ROOF DECK SYSTEM INTERIOR INVERT JANITOR JOINT (S) KITCHEN KIPS LAMINATE (D) LAVATORY LEFT HAND

LENGTH

LIGHTING

LOUVER

MANHOLE

MASONRY

MATERIAL

MAXIMUM

METAL

MECHANICAL

MEMBRANE

MEZZANINE

MISCELLANEOUS

MOISTURE RESISTANT

NOT IN CONTRACT

NOT TO SCALE

GYPSUM WALL BOARD

MINIMUM

MOUNTED

NEAR SIDE

NOMINAL

NORTH

NUMBER

ON CENTER

OPENING

OVERALL

PIECES

PAINTED

PARTITION

PAYEMENT

PERIMETER

PLASTER

PLUMBING

PLYWOOD

PRECAST

QUANTITY

PREFINISHED

QUARRY TILE

RADIUS, RISER

REFRIGERATOR

REINFORCE (D) (ING)

REFERENCE

REQUIRE (D)

RETURN AIR

RIGHT HAND

RIGHT-OF-WAY

ROOF DRAIN

ROUGH OPENING

ROUND OR DIAMETER

SMOKE DETECTOR

SOLID CORE

SPECIFICATION

STAINLESS STEEL

ROOM

SCHED.

SECT.

SHWR.

SHT.

STA.

STD.

STL

STOR.

SANITARY

SCHEDULE

SECTION

SHOWER

SIMILAR

SOUTH

SPACES

SPL. CTG. SPECIAL COATING

SQUARE

STATION

STEEL

STORM

STANDARD

STORAGE

STRUCTURAL

SUPPLY AIR

SUSPEND (ED)

TILE CEILING

SYMMETRICAL

SUPERVISION (VISOR)

SUSPENDED ACOUSTICAL

SHEET

REVISE (D)

RESILIENT

PAIR

PANEL

OPPOSITE

OUTSIDE AIR

OUT TO OUT

OVERHEAD

OUTSIDE DIAMETER

OVERALL LENGTH

PER LINEAR FOOT

POUNDS PER SQUARE INCH

PLATE (PROPERTY LINE)

PLUMBING CONTRACTOR

PRECAST CONCRETE

PUBLIC ADDRESS

PERFORATE (D)

OFFICE

MACHINE BOLT

MFR./MFG. MANUFACTURE (R) (ING)

POUND

LIVE LOAD

LIN.

LVR.

LB. (#)

MEZZ.

MTD.

NOM.

N.T.S.

NO. (\*)

OYHD.

PCS.

PTD.

M.R.G.W.B.

M.B.

LEVELING PLATE

LINEAL (LINEAR)

LONG LEG HORIZONTAL

LONG LEG VERTICAL

MASONRY OPENING

METAL TOILET PARTITION

TACK BOARD TER. TERRAZZO THICK (NESS) TONGUE & GROOVE TOP & BOTTOM TOP CHORD, TOP OF CURB ELEVATION TOP OF STEEL TOP OF WALL ELEV T.B. TOGGLE BOLT TREAD TUBE STEEL TYPICAL UNFINISHED URINAL Y.B. VAPOR BARRIER VERTICAL VESTIBULE VINYL COMPOSITION TILE WAINSCOT WATER CLOSET WATER PROOF (ING) WELDED WIRE MESH WITH W/O WITHOUT WD. WOOD W.D. WOOD DOOR YD. YARD

COLUMN GRID

REFERENCES

ELEVATION LETTER

ELEVATION SHEET

DIRECTION OF DETAIL

-DETAIL SECTION SHEET

DRAWING REVISION

EQUIPMENT NUMBER

ROOM NUMBER

WINDOW LETTER

CEILING HEIGHT

- DOOR NUMBER

EQØØ

8'-4"

ROOM NAME , ROOM NAME

REVISED DATE)

NUMBERS ONLY (SEE

# T & G T & B YERT

### Dublin, Ohio 43017 YARD HYDRANI YARD DRAIN SYMBOLS LEGEND REFER TO STRUCTURAL, MECHANICAL PLUMBING AND ELECTRICAL SHEETS FOR SPECIFIC SYMBOLS

### LOCATION MAP DETAIL SECTION LETTER

DETAIL SECTION LETTER SHEET NO. DESCRIPTION DETAIL SECTION SHEET

Cl	COVER SHEET/ CODE INFORMATION
<del>- S1</del>	SITE PLANNOTES
DI	FIRST FLOOR EXIST/DEMO PLAN/NOTES
D2	SECOND FLOOR EXIST./DEMO PLAN/NOTES
D3	FIRST FLOOR EXIST./DEMO REFLECTED CEILING PLAN/NOTES
D4	SECOND FLOOR EXIST./DEMO REFLECTED CEILING PLAN/NOTES
A1	FIRST FLOOR PLANMOTES
<b>A</b> 2	SECOND FLOOR PLAN/NOTES

SECOND FLOOR PLAN/NOTES PLAN NOTES/CABINET ELEVATIONS FIRST FLOOR REFLECTED CEILING PLAN SECOND FLOOR REFLECTED CEILING PLAN FIRST FLOOR OCCUPANCY PLAN SECOND FLOOR OCCUPANCY PLAN ENLARGED TOILET PLANS

ACCESSIBLY NOTES/DETAILS

PLUMBING PLANS/NOTES

DOOR SCHEDULE

- DETAIL SECTION LETTER - DETAIL SECTION SHEET

, INDICATES REFERENCE TO DETAIL AT LARGE NORTH ARROW

### BUILDING DATA

### PROJECT SCOPE

USE GROUP:

New Owner/Use For An Existing Office Building:

5626 Frantz Rd.

EXIST. 2 STORY BUILDING, UNPROTECTED, NEW SPRINKLER SYSTEM: FIRST FLOOR - 21,651 SF, SECOND FLOOR - 20,667 SF TOTAL BLDG AREA- 42,318 SF

JISTA COMMUNITY CHURCH

BUILDING CODE: 2017 OBC, 2017 OPC, 2017 OMC, 2017 NEC, 2009 ICC/ANSI A117.1, 2012 IECC, 2015 IFGC

CONSTRUCTION II-B - 2 STORY, UNPROTECTED - METAL STUDS FRAME & METAL FRAME ROOF TRUSSES

OCCUPANCY: MAX. ALLOWED PER ØBC MAXIMUM ALLOWABLE OCCUPANT LOAD:

A-3 - RELIGIOUS

FIRST FLOOR AREAS	SF/PERSON	LOAD
OFFICE - 8,037 SF	100	81
CLASSROOMS - 4,754 SF	20	238
CAFE - 1,830 SF	15	122
CAFE PREP - 398 SF	200	2
FIRST FLOOR OCCUPANTS		443
SECOND FLOOR AREAS	SF/PERSON	LOAD
OFFICE - 4,024 SF	100	41
WORSHIP - 6,908 SF	POSTED	234
SECOND FLOOR OCCUPAN	TS	275

EGRESS: MIN. NUMBER OF EXITS PER OBC REQUIRED EGRESS CAPACITY

> BLDG OCCUP LOAD EXITS FIRST FLR - 21,651 SF SECOND FLR 20,667 SF 275

TRAVEL DISTANCE: 250' (PER OBC)

- FIRE EXTINGUISHERS PER OBC, NFPA 10, FIRE CODE AND LOCAL FIRE MARSHALL. PROVIDE (8 MIN.) MULTI-PURPOSE DRY CHEMICAL, ABC RATING, 10 POUND, WALL HUNG FIRE EXTINGUISHERS FOR BUILDING, UNLESS AUTHORITY HAVING JURISDICTION DIRECTS OTHERWISE. MOUNT A FIRE EXTINGUISHER @ EACH MAN DOOR, TOP @ 4'-0" AFF. THE EXISTING FIRE EXTINGUISHERS SHALL REMAIN & ARE INDICATED ON
- 2. THE BUILDING HAS AN EXISTING FIRE ALARM SYSTEM. ADD THE NEW DEVICES AS REQUIRED PER THE NEW PLANS. DESIGN BY OTHERS. COORD, W/ THE OWNER
- 3. THE BUILDING WILL BE ADDING A FULL SPRINKLER SYSTEM TO THE ENTIRE BUILDING. DESIGN BY OTHERS. COORD. W/ THE OWNER

### GENERAL NOTES

**OWNER INFO:** 

OWNER CONTACT: MIKE SMITH

THE CONTRACTORS SHALL FURNISH ALL MATERIAL, LABOR AND EQUIPMENT TO COMPLETE ALL OF THE WORK.

5626 FRANTZ RD. DUBLIN, OH 43017

P.O. Box 3278 Dublin, OH 4308

- ALL WORK SHALL CONFORM WITH THE MOST RECENT EDITION OF THE OHIO BUILDING CODE. IT IS THE RESPONSIBILITY OF THE CONTRACTORS TO COMPLY WITH THE APPROPRIATE SECTIONS OF THE CODES DURING EACH PHASE OF THE WORK
- THE CONTRACTORS SHALL CAREFULLY STUDY AND COMPARE THE CONTRACT DOCUMENTS WITH EACH OTHER AND SHALL AT ONCE REPORT TO THE ARCHITECT ERRORS, INCONSISTENCIES OR OMISSIONS DISCOVERED. IF THE CONTRACTORS PERFORMS ANY CONSTRUCTION ACTIVITY KNOWING IT INVOLVES A RECOGNIZED ERROR, INCONSISTENCY OR OMISSION IN THE CONTRACT DOCUMENTS WITHOUT SUCH NOTICE TO THE ARCHITECT, THE CONTRACTOR SHALL ASSUME APPROPRIATE RESPONSIBILITY FOR SUCH PERFORMANCE AND SHALL BEAR AN APPROPRIATE AMOUNT OF THE ATTRIBUTABLE COSTS FOR
- 4. ALL CONTRACTORS AND SUBCONTRACTORS ARE RESPONSIBLE FOR THEIR OWN COMPLETE REVIEW OF THE CONSTRUCTION DOCUMENTS. EACH SUBCONTRACTOR IS RESPONSIBLE FOR WORK OF THEIR TRADE REGARDLESS OF WHERE THAT WORK IS SHOWN OR INDICATED IN THE CONTRACT DOCUMENTS.
- 5. ANY MATERIAL OR LABOR, WHICH MAY NOT BE SHOWN ON THE DRAWINGS OR NOT SPECIFIED, BUT WHICH IS OBVIOUSLY NECESSARY TO COMPLETE THE WORK SHALL BE FURNISHED WITHOUT ADDITIONAL COST.
- THE GENERAL CONTRACTOR SHALL SECURE AND PAY FOR ALL PERMITS AND INSPECTIONS REQUIRED AND SHALL ALSO PAY FEES REQUIRED FOR THE GENERAL CONSTRUCTION. PLUMBING, ELECTRICAL, HVAC, AND FIRE PROTECTION SUB- CONTRACTORS SHALL PAY FOR THEIR PERMITS. COORDINATE WITH THE OWNER.
- 1. ANY CHANGES INCLUDING TIME DELAYS RESULTING FROM THE USE OF APPROVED EQUALS SHALL BE BORN BY THE CONTRACTOR. ANY EFFECTS ON OTHER PORTIONS OF THE WORK CREATED BY SUCH CHANGES SHALL BE COORDINATED BY ALL CONTRACTORS.
- 8. DRAWINGS INDICATE THE MINIMUM STANDARDS BUT, IF ANY INDICATED WORK SHOULD BE DISCOVERED TO BE SUBSTANDARD TO ANY ORDINANCES, LAWS, CODES, RULES OR REGULATIONS BEARING ON THE WORK, THE CONTRACTOR SHALL CONTACT THE ARCHITECT AND/OR CONSTRUCTION MANAGER AND UPON HIS DIRECTION SHALL EXECUTE THE WORK CORRECTLY.
- VERIFY UNDERGROUND UTILITIES AND CONDITIONS WITH THE OWNER AND PROPER AUTHORITY. CALL 811, (3) THREE DAYS BEFORE DIGGING.
- 10. DO NOT SCALE DRAWINGS. WRITTEN DIMENSIONS SHALL CONTROL ALL LOCATIONS. ALL DIMENSIONS ARE TO FACE OF ROUGH FRAMING OR FACE OF FOUNDATION, UNLESS NOTED
- CONTRACTOR SHALL COORDINATE PRE-WIRING OF ANY AND ALL OWNER SUPPLIED EQUIPMENT.
- 12. CONTRACTORS SHALL KEEP THE JOB SITE NEAT AND ORDERLY, REMOVING SCRAP MATERIAL DAILY AND SHALL CLEAN SITE AND THE WORK THOROUGHLY UPON COMPLETION.
- 13. THE CONTRACTORS SHALL BE DEEMED TO HAVE INSPECTED THE SITE BEFORE SUBMITTAL OF BIDS AND SATISFIED HER/HIMSELF AS TO ACTUAL EXISTING GRADES, LEVELS, DIMENSIONS AND DECLINATIONS AND THE TRUE CONDITIONS UNDER WHICH THE WORK IS TO BE PERFORMED.
- 14. THE BUILDING PLAN REVIEW AUTHORITY IS:

THE CITY OF DUBLIN BUILDING DEPARTMENT 5800 SHIER-RINGS RD. DUBLIN, OHIO 43017 614-761-6550



475 Village Park Dr Powell. Ohio 43065-9178 Office: 614-791-1200 Mobile: 614-271-8420 jclarke@clarkearchitects.com

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DATE: FEBRUARY 14, 2023

the drawings shall be permitted.

REVISION DATES:

PROJECT:

VISTA COMMUNITY CHURCH 5626 FRANTZ RD.

PROJECT NUMBER: CAI202175

DUBLIN, OHIO 43017

SHEET TITLE:

COVER SHEET/CODE INFORMATION

198'-3 1/2"

CLARKE ARCHITECTS, INC.

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FEBRUARY 14, 2023

DATE:

REVISION DATES:

PROJECT:

VISTA COMMUNITY CHURCH 5626 FRANTZ RD. DUBLIN, OHIO 43017

PROJECT NUMBER: CAI202175


SHEET TITLE:

FIRST FLOOR EXISTING/ DEMO PLAN/NOTES


SHEET NUMBER:

11. THERE ARE NEW SLAB TRENCHES REQUIRED FOR THE NEW PLUMBING, SEE

THE ATTACHED PLUMBING SHEETS.

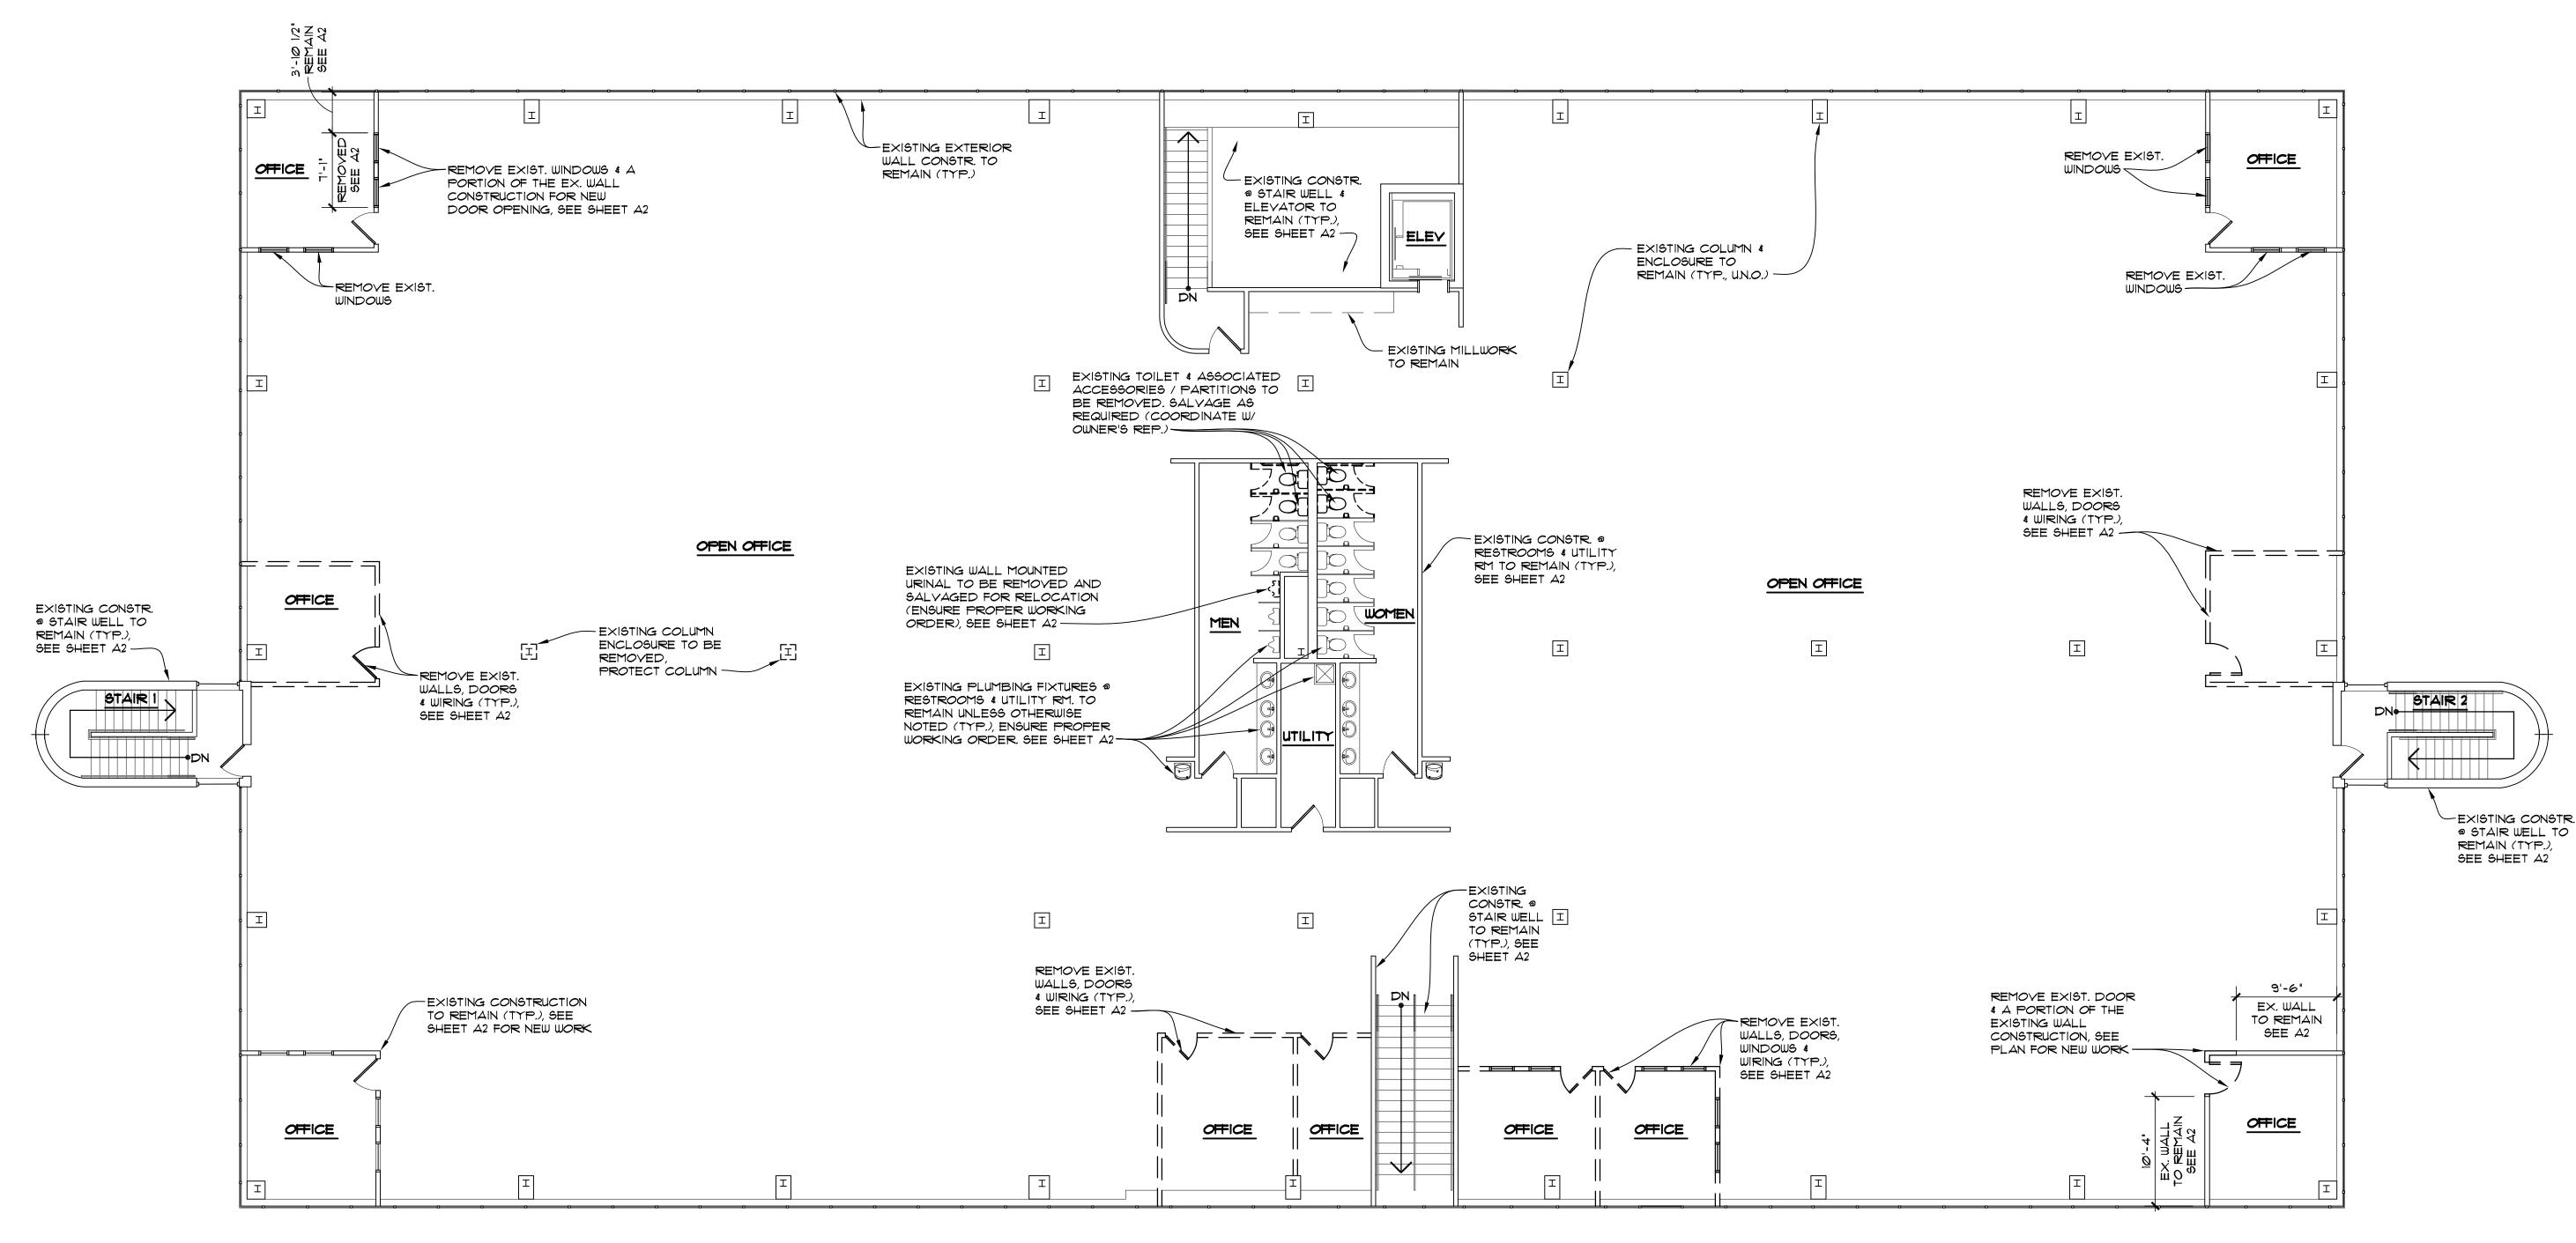



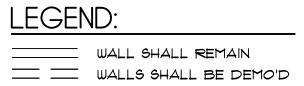

### DEMO GENERAL NOTES:

- 1. ALL INTERIOR WALLS, FIXTURES & CEILINGS INDICATED ARE BEING REMOVED & ARE NON BEARING BACK TO AN EMPTY SPACE.
- 2. CUT, CAP, PATCH & REMOVE ALL EXISTING FLOOR RECEPTACLES, FLOOR CONDUIT & PLUMBING, LINES THAT PENETRATE THE FLOOR.
- 3. COORD. W/ THE NEW PLANS FOR REMOVAL OF ALL MATERIALS NOT INDICATED ON THE DEMO DWGS.
- REMOVE ANY & ALL VEGETATION & PLANTS AGAINST OR CLOSE TO THE BLDG, FIELD VERIFY
- 5. REMOVE & DISPOSE ALL EXISTING FLOOR COVERINGS, IN AREAS OF WORK, DEMO'D SPACE AS INDICATED. SUB FLOOR MUST BE SMOOTH, LEVEL, UNIFORM & STRUCTURALLY SOUND CONCRETE FLOOR READY TO RECEIVE NEW FLOORING. REMOVE FLOOR ADHESIVE & PREP FINISH FOR THE OWNERS NEW FLOOR FINISH.
- 6. VERIFY CEILING REGISTERS & DUCT WORK. SEE THE MECHANICAL SHEET BY OTHERS NEW WORK.
- 7. VERIFY EXISTING MECH., PLUMBING & ELECTRICAL IN EXISTING DEMO'D AREAS BEING REMOYED, COORD. NEW LOCATIONS W/ THE OWNER & NEW ENGINEERING SHEETS.



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DATE:

REVISION DATES:

PROJECT:

VISTA COMMUNITY CHURCH 5626 FRANTZ RD.

PROJECT NUMBER: CAI202175

DUBLIN, OHIO 43017

SHEET TITLE:

SECOND FLOOR EXISTING/ DEMO PLAN/NOTES

SHEET NUMBER:

**D**2



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FEBRUARY 14, 2023

REVISION DATES:

PROJECT:

VISTA COMMUNITY CHURCH

5626 FRANTZ RD. DUBLIN, OHIO 43017

PROJECT NUMBER: CAI202175

SHEET TITLE:

FIRST FLOOR EXISTING / DEMOLITION REFLECTED CEILING PLAN

BY OTHERS NEW WORK.

		REVISION DATES:
LIGHTING LEGEND		
EXIT	EXISTING EGRESS LIGHTING	
EXIT	EXISTING EGRESS LIGHTING TO BE REMOVED OR SALVAGED FOR RELOCATION	PROJECT:
EXIT	EXISTING EGRESS LIGHTING W/ DIRECTIONAL SIGNAGE	VISTA COMMUNI 5626 FRANTZ RD.
	EXISTING EGRESS LIGHTING W/ DIRECTIONAL SIGNAGE TO BE REMOVED OR SALVAGED FOR RELOCATION	DUBLIN, OHIO 43017
₹ <sub>WM</sub>	EXISTING EMERGENCY LIGHTING	PROJECT NUMBER: CAI202175
₹ <u>₩</u> M	EXISTING EMERGENCY LIGHTING TO BE REMOVED OR SALVAGED FOR RELOCATION	SHEET TITLE:
	EXISTING 2' x 2' IN-LAY LIGHT	SECOND FLOOR
	EXISTING 2' x 2' LIGHT TO BE REMOVED OR SALVAGED FOR RELOCATION	/ DEMOLITION F CEILING PLAN
	EXISTING 2' x 4' IN-LAY LIGHT	
	EXISTING 2' × 4' LIGHT TO BE REMOVED OR SALVAGED FOR RELOCATION	SHEET NUMBER:
	EXISTING CEILING GRID TO REMAIN (TILES REMOVED)	
	EXISTING CEILING GRID & TILES TO BE REMOVED	
		-



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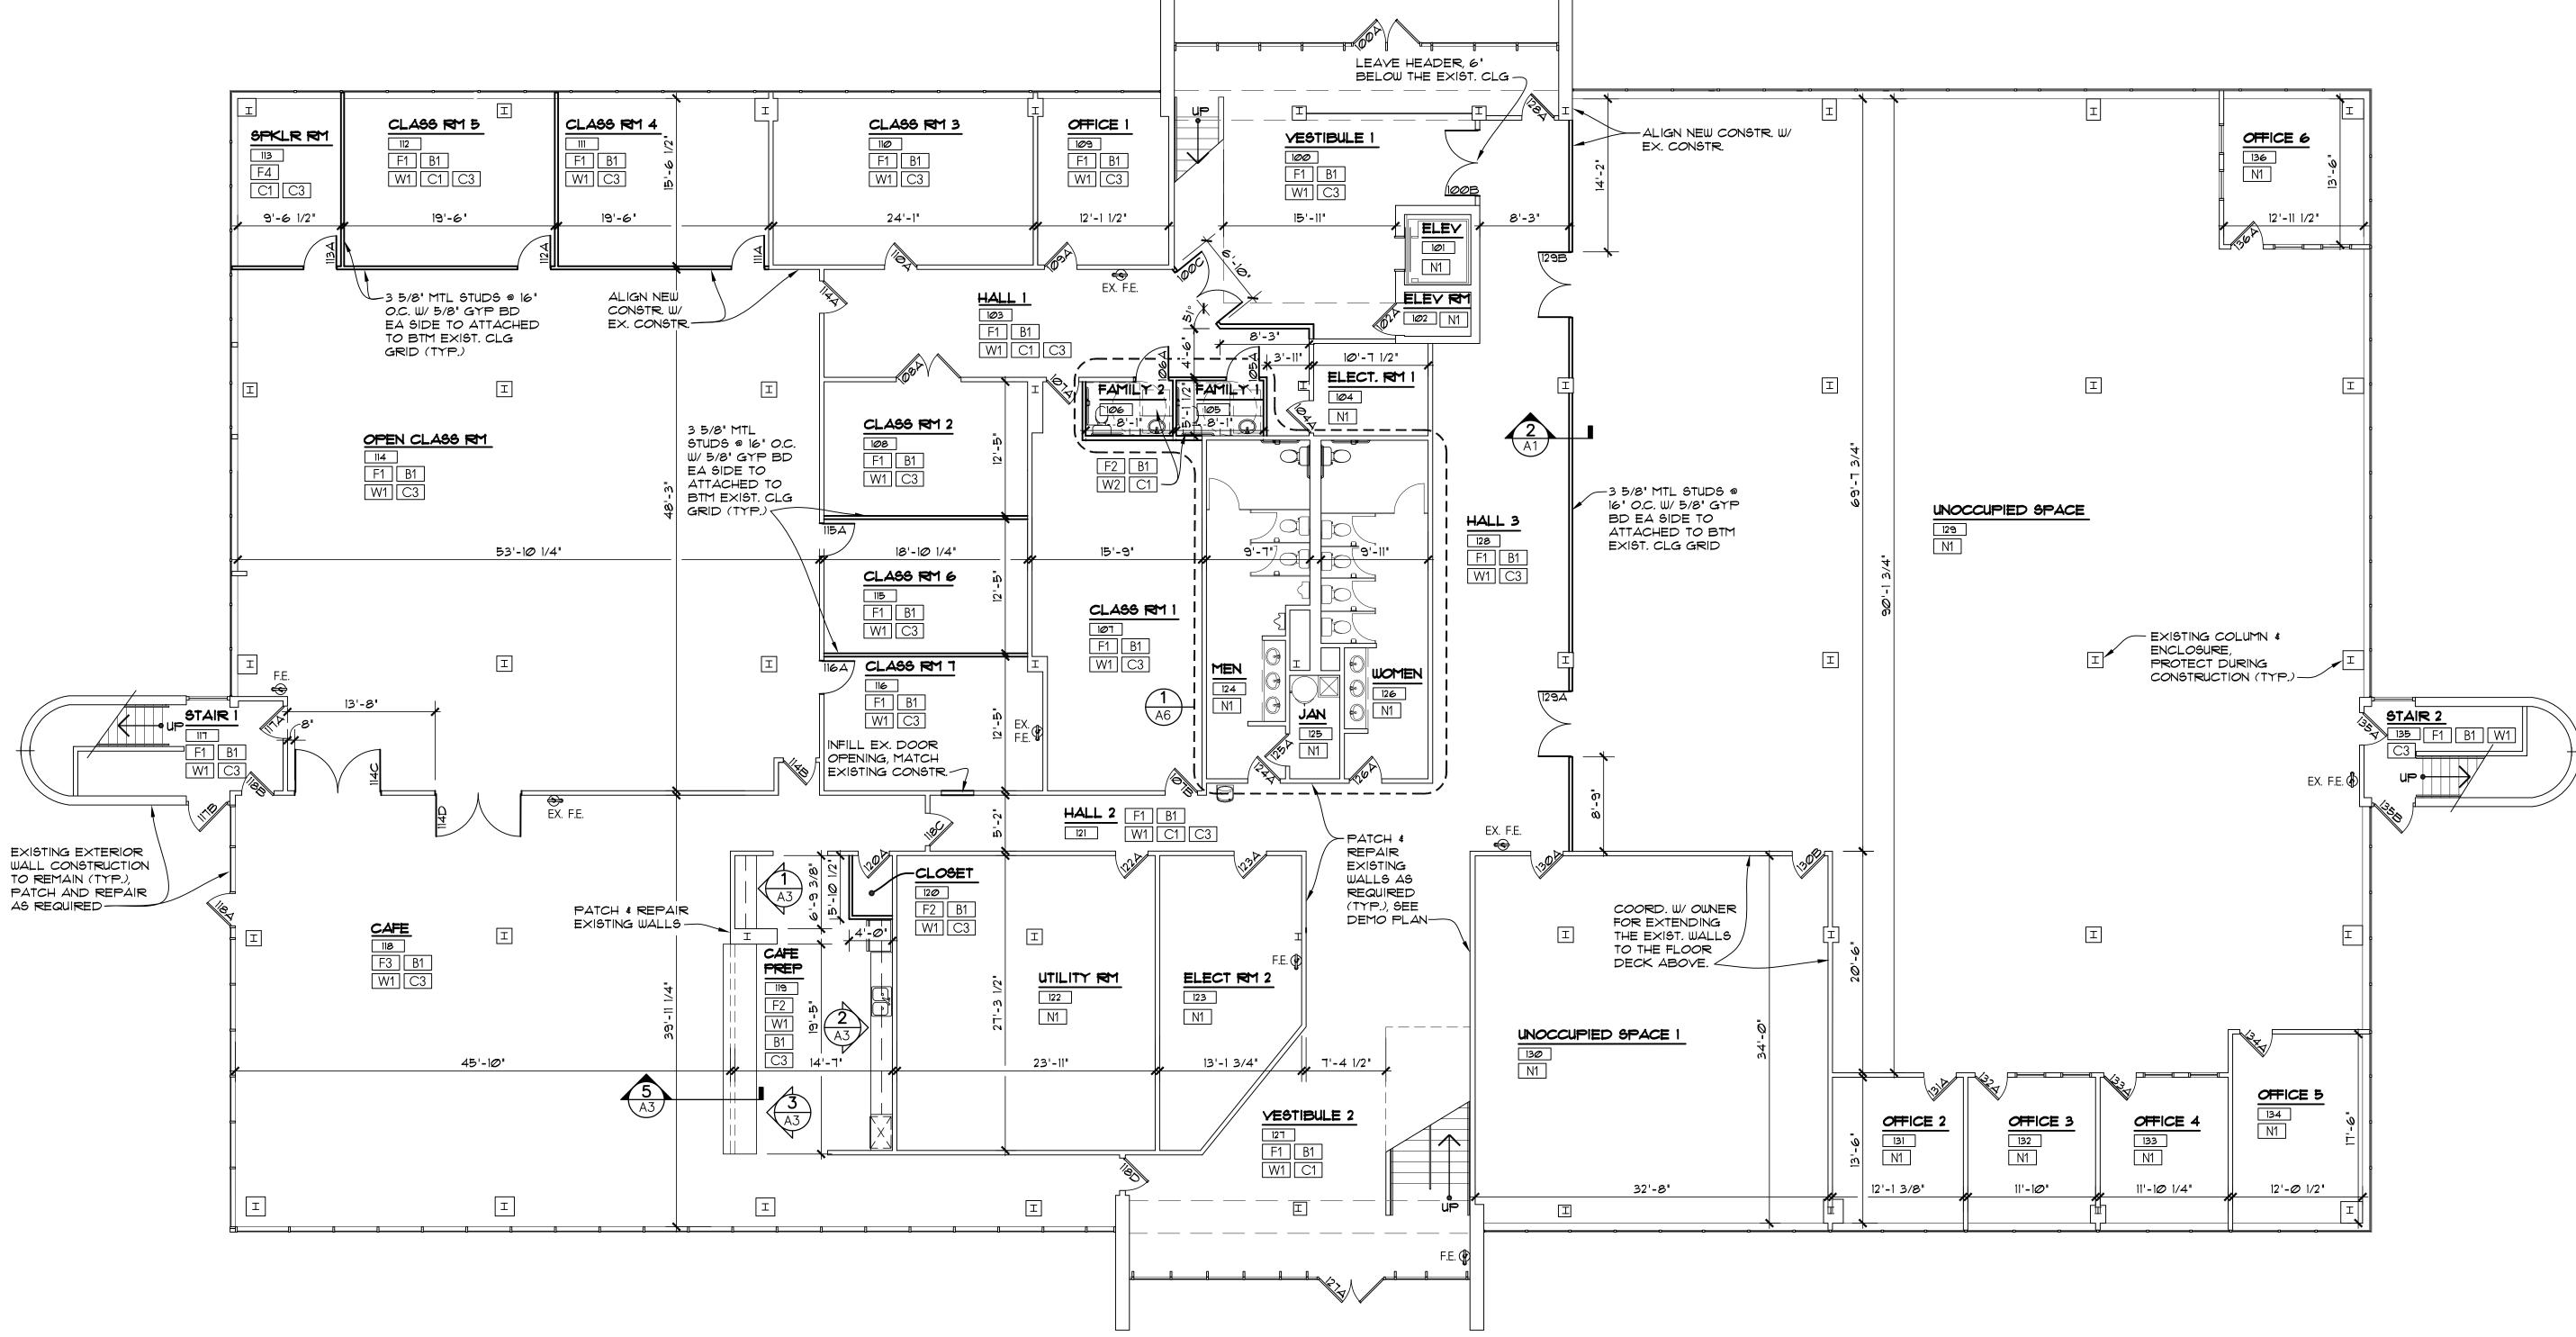
FEBRUARY 14, 2023

DATE:

REVISION DATES:

VISTA COMMUNITY CHURCH 5626 FRANTZ RD.

SECOND FLOOR EXISTING / DEMOLITION REFLECTED CEILING PLAN



# FIRST FLOOR BUILDING PLAN 1/8" = 1'-0"

### FINISH NOTES:


1. WALL FLOOR & CEILING SHALL NOT EXCEED FLAME SPREAD CLASSIFICATIONS IN THE 2017 OBC PER SECTION 803 & TABLE 803.11 ALL APPLIED FINISHES SHALL MEET OR EXCEED THE FLAME SPREAD \$ DEVELOPED SMOKE REQUIREMENTS AS SET FORTH IN THE BUILDING CODE.

> EXIT PASSAGE WAYS: CLASS A CORRIDORS: CLASS B ROOMS - FLOORS/WALLS/CEILING: CLASS C


- 2. COORDINATE ALL FINISH COLOR, TYPES & STYLES W/ THE OWNER BEFORE ORDERING & INSTALLATION OF FINISHES.
- 3. THE EXACT FINISH OF ALL PRODUCTS & SURFACES SHALL BE FROM THE MANUFACTURER'S STANDARDS. OWNER SHALL SELECT COLORS & APPROVE ALL FINISHES BEFORE ORDERING
- 4. ALL FINISH MATERIALS SHALL BE INSTALLED FOR MANUFACTURERS REQUIREMENTS & INSTRUCTIONS.
- 9. NEW YINYL BASE BD. (WHEN NEW CARPET INSTALLED)
- 10. RE-USE MINI BLINDS THROUGHOUT,, REPLACE ANY DAMAGED UNITS
- 6. NEW PAINT THROUGHOUT. (EXCEPT UNOCCUPIED AREAS)
- 7. RE-USE EXIST. CEILING TILES & LIGHTS, REPAIR/REPLACE AS NEEDED.
- 8. NEW CARPET THROUGHOUT. (EXCEPT UNOCCUPIED AREAS)



SEE SHEET A3 FOR PLAN GENERAL NOTES

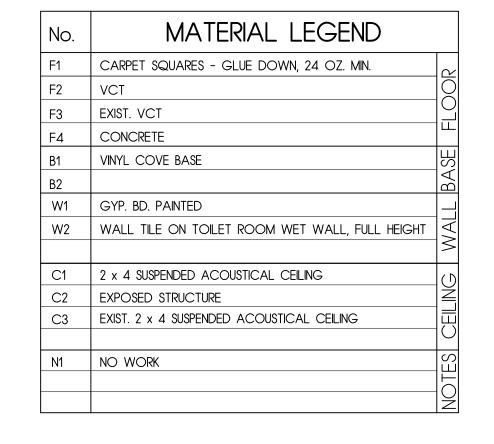

A1 N.T.S.

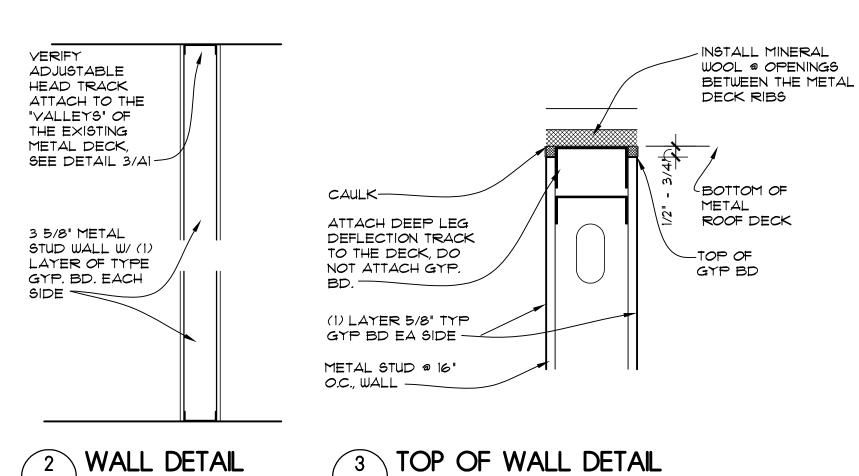

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Office: 614-791-1200

Mobile: 614-271-8420

Powell, Ohio 43065-9178

jclarke@clarkearchitects.com

REVISION DATES:

PROJECT:


VISTA COMMUNITY CHURCH 5626 FRANTZ RD.

PROJECT NUMBER: CAI202175

DUBLIN, OHIO 43017

SHEET TITLE:

FIRST FLOOR BUILDING PLAN/NOTES

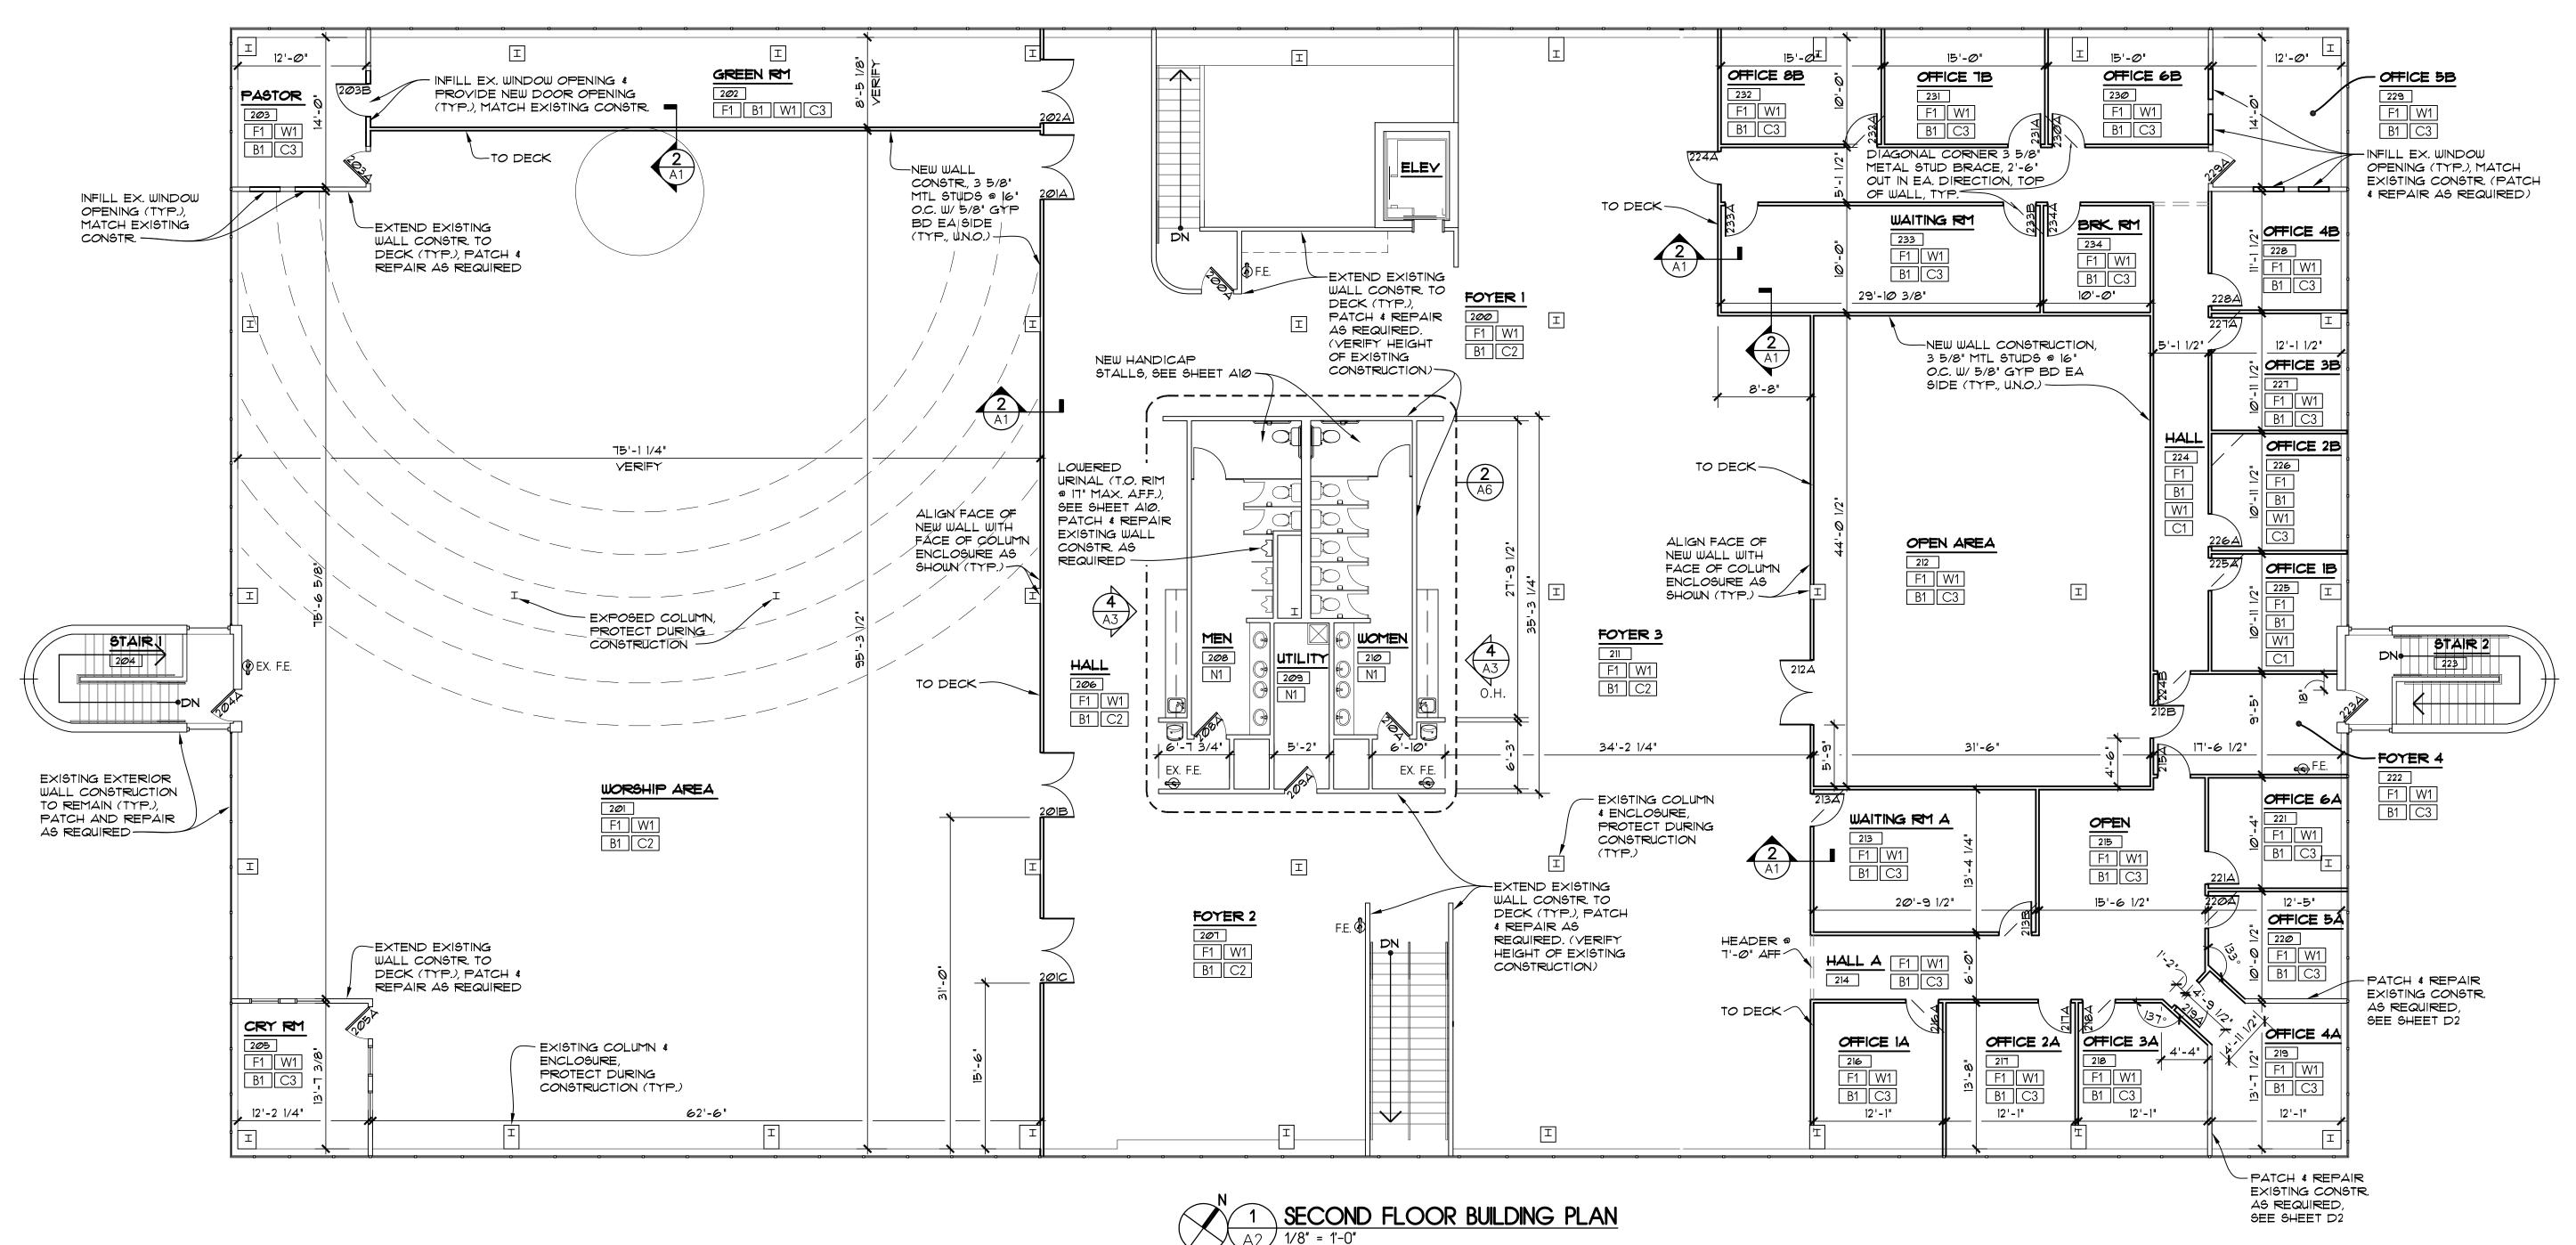

NOTES:

SEE SHEET A3 FOR PLAN GENERAL NOTES

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FEBRUARY 14, 2023

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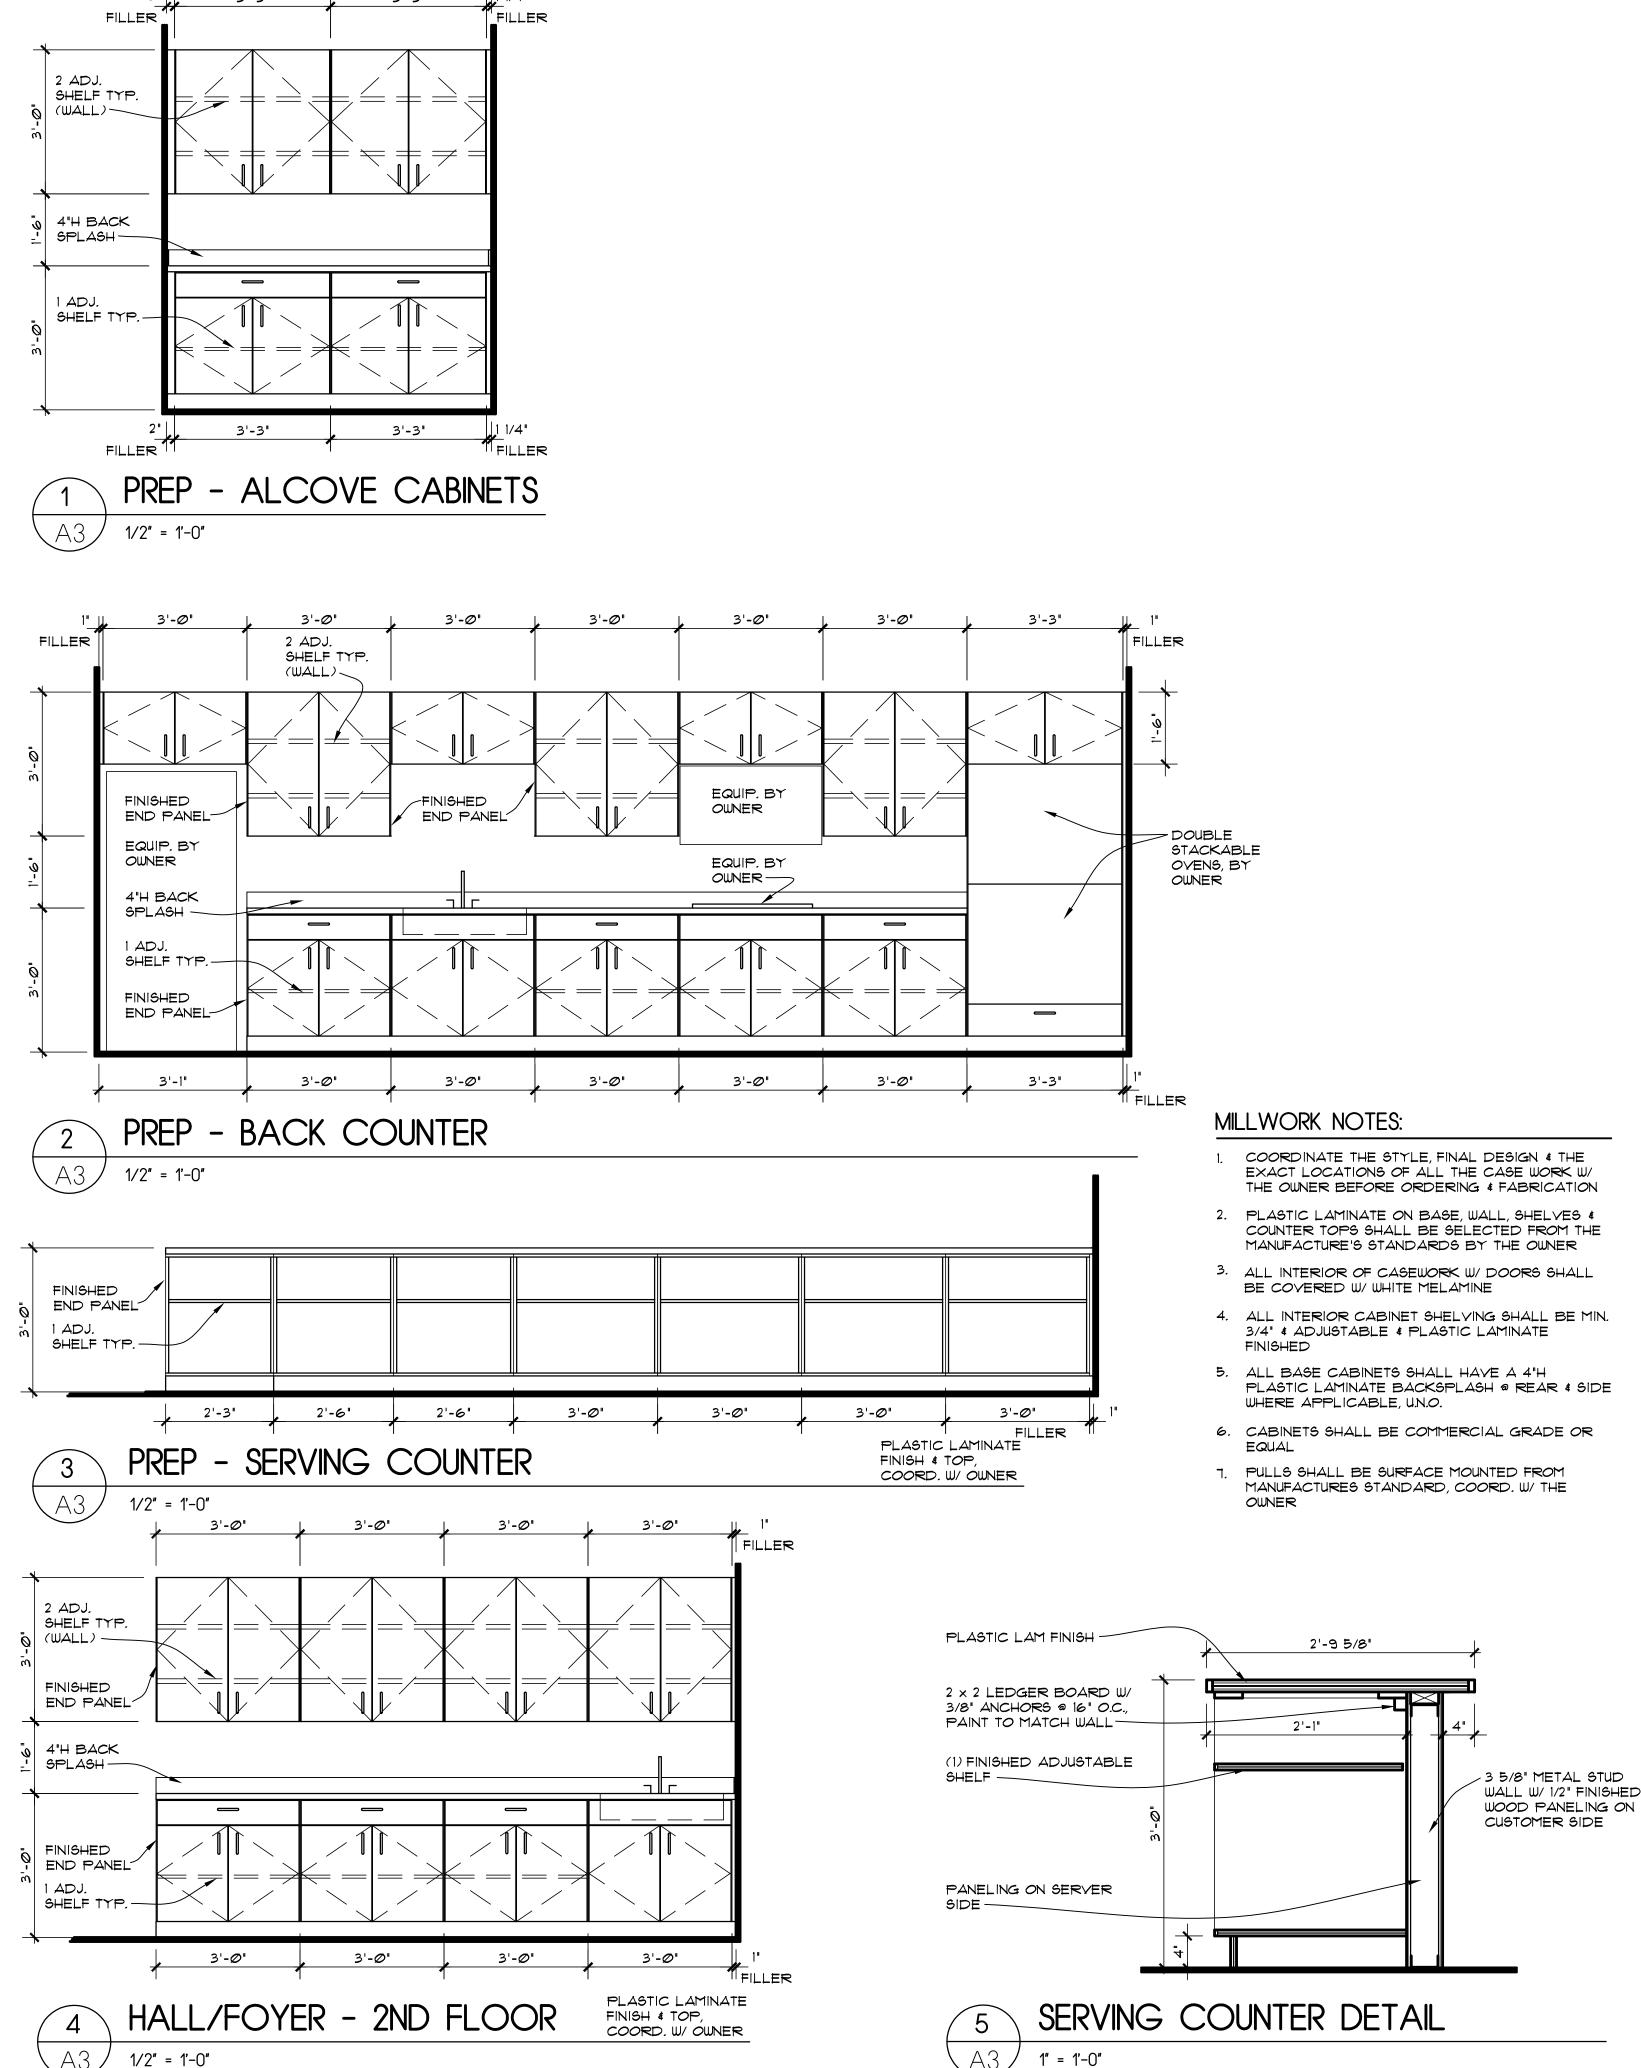
VISTA COMMUNITY CHURCH 5626 FRANTZ RD. DUBLIN, OHIO 43017

PROJECT NUMBER: CAI202175

SHEET TITLE:

SECOND FLOOR BUILDING PLAN

SHEET NUMBER:



### PLAN GENERAL NOTES:

- 1. THIS IS AN EXISTING 2 STORY OFFICE BUILDING, NON-COMBUSTIABLE BUILDING. THIS BUILDING SHALL BE GETTING A SPRINKLER SYSTEM THRU OUT. THE NEW OWNERS WILL BE CHANGING THE BUILDING USE TO A-3 RELIGIOUS
- 2. COMPLY W/APPLICABLE LOCAL, STATE, & FEDERAL CODES & REGULATIONS PERTAINING TO SAFETY OF PERSONS, PROPERTY & ENVIRONMENTAL PROTECTION
- 3. INTERIOR STUD WALLS SHALL BE NON-BRG 3 5/8" & 6" x 22 GA. MTL. STUDS @ 16" O.C., 12'-0" HIGH. ALL DIMENSIONS ARE TO THE FACE OF NEW METAL STUDS & FACE OF EXISTING WALLS. ALL NEW WALLS SHALL BE COVERED W/ 5/8" GYP. BD., FULL HEIGHT, UNLESS NOTED OTHERWISE, COORD. W/ THE OWNER.
- 4. IF DIMENSIONS ARE IN QUESTION THE CONTRACTOR SHALL BE RESPONSIBLE FOR OBTAINING CLARIFICATION FROM THE OWNER OR ARCHITECT BEFORE CONTINUING W/ CONSTRUCTION.
- 5. INSTALL GREEN BOARD IN ANY NEW WET CONDITION. INSTALL GREEN BOARD MIN. 8'-0" HIGH ON THE TOILET WET WALLS.
- 6. PROVIDE TOP OF WALL BRACING ABOVE CEILING OR DIAGONAL WHERE & AS REQ'D. WALL BRACING SHOWN DIAGONAL ON TOP OF THE WALLS. SEE THE BUILDING PLANS, VERIFY LOCATION W/ FIELD CONDITIONS.
- T. SEAL ALL EXISTING OPENINGS IN THE EXTERIOR, INTERIOR WALLS & FLOOR SYSTEM ABOVE VERIFY ALL CONDITIONS. SEAL OPENINGS W/ MATERIALS COMPATIBLE W/ ADJACENT CONSTRUCTION OR RATED ASSEMBLY AS REQUIRED.
- 8. IF WOOD IS USED FOR BLOCKING, ALL WOOD IN CONTACT W/ CONCRETE SHALL BE PRESSURE-TREATED. FASTENERS SHALL COMPLY W/ APPLICABLE CODES. IN ALL CONDITIONS WHERE PRESSURE-TREATED WOOD IS USED, FASTENERS, ANCHOR BOLTS, WASHERS, NAILS, ETC. SHALL BE TRIPLE HOT DIPPED OR STAINLESS STEEL.
- 9. PROVIDE IN-WALL BLOCKING AS REQUIRED FOR ALL TOILET ACCESSORIES, CABINETS, WALL MOUNTED MONITORS, WALL MOUNTED LIGHT FIXTURES, GRAB BARS & ANY REQUIREMENTS BY THE OWNER. ALL IN-WALL BLOCKING SHALL BE WOOD OR METAL FRAMING.
- 10. FIRESTOPPING SHALL BE PROVIDED TO CUT OFF ALL CONCEALED DRAFT OPENINGS (VERT. & HORIZ.) & TO FORM AN EFFECTIVE FIRE
- 11. PER OBC 111.2.2 FIRE BLOCKING SHALL BE PROVIDED IN CONCEALED SPACES OF STUD WALLS AND PARTITIONS, INCLUDING FURRED SPACES, AND PARALLEL ROWS OF STUDS OR STAGGERED STUDS, AS FOLLOWS: A. VERTICALLY AT THE CEILING AND FLOOR LEVELS. B. HORIZONTALLY AT INTERVALS NOT EXCEEDING 10 FEET
- 12. THE EQUIPMENT ROUGH-INS AS SHOWN ARE BASED UPON AVAILABLE INFORMATION. HOWEVER, IN SOME INSTANCES, THE OWNER OR SUPPLIER MAY SUBSTITUTE OR THE EQUIPMENT ITEM MAY VARY FROM WHAT IS SHOWN, THEREFORE, THE CONTRACTOR SHALL VERIFY ALL CRITICAL DIMENSIONS W/ THE SUPPLIER & OWNER PRIOR TO CONSTRUCTION. FAILURE OF THE CONTRACTOR TO VERIFY THESE DIMENSIONS SHALL PLACE THE RESPONSIBILITY FOR ANY SUBSEQUENT RELOCATION DIRECTLY ON THE CONTRACTOR.
- 13. VERIFY W/ THE OWNER CONCERNING ALL EQUIPMENT BEFORE ORDERING & ROUGH-INS ARE COMPLETED & GYP BOARD IS INSTALLED
- 14. SEE SHEET AI FOR THE FINISH NOTES & MATERIAL LEGEND.
- 15. ALL FINISH COLORS SHALL MATCH, COORDINATE W/ THE OWNER.
- 16. NEW PAINT THROUGHOUT. (EXCEPT UNOCCUPIED AREAS)
- 17. NEW CARPET THROUGHOUT. (EXCEPT UNOCCUPIED AREAS)
- 18. NEW YINYL BASE BD. (WHEN NEW CARPET INSTALLED)
- 19. RE-USE EXIST. CEILING TILES & LIGHTS, REPAIR/REPLACE AS NEEDED.
- 20. SEE SHEET A9 FOR THE DOOR SCHEDULE "100A". DOORS SHALL BE INSTALLED A MIN. OF 4 1/2" AWAY FROM THE PERPENDICULAR WALL. FOR CLOSETS, THE DOOR SHALL BE CENTERED IN THE WALL. UNLESS NOTED OTHERWISE.
- 21. REUSE INTERIOR DOORS IF POSSIBLE, FIELD VERIFY CONDITION & COORD, W/ OWNER.
- 22. ALL OF THE ENTRY DOORS SHALL REMAIN UNLOCKED WHEN THE SPACE IS OCCUPIED. THE EGRESS LOCKING DEVICE SHALL BE DISTINGUISHABLE AS LOCK OR UNLOCK OR THE LOCKING DEVICE SHALL ALWAYS BE UNLOCK FROM THE INSIDE. ADD NOTE ON THE DOOR "THIS DOOR IS TO REMAIN UNLOCKED WHILE THE BUILDING IS OCCUPIED". OPTION FOR ALL OF THE EXIT DOORS TO HAVE PANIC HARDWARE & THEN THE SIGN IS NOT REQUIRED.
- 23. THERE SHALL BE A FLOOR OR LANDING ON BOTH SIDES OF ALL DOORS. SUCH FLOOR OR LANDING SHALL BE @ THE SAME ELEVATION ON EACH SIDE OF THE DOOR. LANDINGS SHALL BE LEVEL EXCEPT FOR THE EXTERIOR LANDINGS WHICH ARE PERMITTED TO HAVE A SLOPE NOT EXCEEDING 1:50.
- 24. PREPARE SLAB TO RECEIVE FINISH MATERIAL TO INCLUDE FLOOR PATCH, LEVELING, CLEANING, ETC. TO ACHIEVE FINAL FINISH MANUFACTURER'S RECOMMENDATIONS FOR SMOOTHNESS & FLATNESS. THE SLAB SHALL BE REPAIRED & PATCHED AS NEEDED. USE QUICK DRYING CONCRETE MIX FOR SLAB REPAIR WORK AS REQUIRED, COORD. W/ THE BUILDING OWNER.
- 25. FE BRACKET WALL MOUNTED FIRE EXTINGUISHERS PER OBC, NFPA 10, OHIO FIRE CODE & LOCAL FIRE MARSHALL. PROVIDE (X)
  MULTI-PURPOSE DRY CHEMICAL, ABC RATING, 10 POUND, WALL HUNG FIRE EXTINGUISHERS (ONE AT EACH EXIT DOOR). UNLESS
  AUTHORITY HAVING JURISDICTION DIRECTS OTHERWISE. INSTALL SO THE CENTER OF THE HANDLE IS MAX. 48" AFF.
- 26. EXISTING FIRE EXTINGUISHERS THAT ARE REQUIRED TO BE REMOVED DUE TO ARCHITECTURAL RENOVATIONS CAN BE RE-USED IN NEW LOCATIONS, ENSURE PROPER WORKING ORDER.
- 27. SEE ENLARGED TOILET PLANS SHEET AS FOR TOILET ACCESSORIES
- 28. THE CONTRACTOR SHALL PROVIDE AN ADA-APPROVED WALL SIGN FOR EACH OF THE TOILET ROOMS. SEE DETAIL ON THE ACCESSIBILITY SHEET.
- 29. THE CONTRACTOR SHALL PROVIDE AN ADA-APPROVED WALL TACTILE EXIT SIGN FOR EACH EXIT DOOR OF THE SPACE. SEE DETAIL ON ACCESSIBILITY SHEET.
- 30. ALL OF THE ENTRY & EXIT DOORS SHALL REMAINED UNLOCK WHEN THE SPACE IS OCCUPIED. ALL OF THE EGRESS DOORS SHALL BE READILY OPERABLE FROM THE EGRESS SIDE W/OUT THE USE OF A KEY OR SPECIAL KNOWLEDGE OR EFFORT.
- 31. THE ACCESSIBILITY SHEET IN THIS SET SHALL TAKE PRECEDENT OVER ALL OTHER SHEETS. SEE ACCESSIBILITY SHEET FOR ALL
- 32. PER OBC 1003.3.1.8: IN BUILDINGS IN OCCUPANCY GROUP "A" HAVING AN OCCUPANT LOAD OF 300 OR LESS, GROUPS "B", "F", "M", "S" AN IN CHURCHES, THE MAIN EXTERIOR DOOR OR DOORS IS PERMITTED TO BE EQUIPPED WITH KEY-OPERATED LOCKING DEVICES FROM THE EGRESS SIDE PROVIDED: A READILY VISIBLE DURABLE SIGN IS POSTED ON THE EGRESS SIDE ON OR ADJACENT TO THE DOOR STATING: "THIS DOOR TO REMAIN UNLOCKED WHEN BUILDING IS OCCUPIED", THE SIGN SHALL BE LETTERS I" HIGH ON A CONTRASTING BACKGROUND.
- 33. THE OPTIONAL INSULATION MATERIAL CONCEALED WITHIN THE WALLS SHALL HAVE A FLAME SPREAD RATING OF 15 OR LESS. THE SMOKE DEVELOPMENT RATING SHALL BE 450 OR LESS. THE INTERIOR LOCATIONS IS INDICATED IN THE PLANS, DECIDED BY THE OWNER. THE OWNER WANTS AN OPTION TO ADD EITHER BATT INSULATION ABOVE THE CEILINGS AS INDICATED FOR SOUND.
- 34. ALL CONTRACTORS SHALL OBTAIN A COMPLETE SET OF PLANS & BE FAMILIAR W/ THE ENTIRE PROJECT IN ORDER TO UNDERSTAND THE COMPLETE SCOPE OF THE PROJECT.
- 35. MAINTAIN CLEAN WORK SITE ON A DAILY BASIS.

REQUIREMENTS.

- 36. THE ARCHITECT IS NOT RESPONSIBLE TO UNCOVER, INVESTIGATE, EXAMINE, TEST, ANALYZE, OR PRESENT METHODS TO MITIGATE CORRECT OR ELIMINATE THE FOLLOWING CONDITIONS THAT MAY OR MAY NOT BE PRESENT AT THE SITE: ASBESTOS, MOLD, RADON, LEAD, ROT, WATER/MOISTURE, ENVIRONMENTAL PROBLEMS, HAZARDOUS MATERIALS, POLLUTANTS, GENERAL DETERIORATION, DETERIORATION OF STRUCTURE & NON STRUCTURAL MEMBERS INADEQUATE SOILS/BEARING CAPACITY, INSECT INFESTATION, TESTING & ADEQUACY OF ELECTRIC/PLUMBING/MECHANICAL SYSTEMS/EQUIPMENT, SUB-SURFACE CONDITIONS, ABOVE GROUND/UNDER GROUND UTILITIES, PREVIOUSLY INSTALLED MATERIALS & WORKMANSHIP.
- 37. RE-USE MINI BLINDS THROUGHOUT. COORD. W/ THE OWNER FOR REPAIR/REPLACEMENT.
- 38. WINDOW SILL 1/2 WALL W/ PLASTIC LAM FINISH APPROX. 8 3/4" DEEP SHOULD BE REPLACED IN AREAS NEEDED. FIELD VERIFY W/ OWNER TO DETERMINE LOCATION. (APPROX. 25% NEEDS TO BE REPLACED)

### SPRINKLER SYSTEM NOTES

THE EXISTING BUILDING SHALL HAVE A SPRINKLER SYSTEM. SPRINKLER SYSTEM SHALL BE DESIGNED BY A CERTIFIED SPRINKLER CONTRACTOR.

CONSTRUCTION DRAWINGS OR SHOP DRAWINGS, OR BOTH, FOR THE INSTALLATION OF FIRE PROTECTION SYSTEMS SHALL BE SUBMITTED TO INDICATE CONFORMANCE TO SECTION 903.3.1.2 OF THE OBC & SHALL BE REVIEWED BY THE BUILDING DEPARTMENT PRIOR TO ISSUANCE OF A PERMIT.

SPRINKLER CONTRACTOR SHALL SUBMIT FOR SPRINKLER PERMIT & SHALL BE RESPONSIBLE FOR ALL REQUIRED INSPECTIONS.

SPRINKLER CONTRACTOR SHALL COORDINATE SPRINKLER HEAD LOCATIONS W/ THE ARCHITECT & OWNER. COORD. W/ THE WALL CONSTRUCTION, CEILINGS & LIGHTING PLAN

### AUTOMATIC FIRE DETECTION & ALARM SYSTEM NOTES THE EXISTING BUILDING HAS A AUTOMATIC FIRE DETECTION & ALARM

THE EXISTING BUILDING HAS A AUTOMATIC FIRE DETECTION & ALARM SYSTEM. THIS SYSTEM SHALL TIE INTO THE EXISTING SYSTEM. THE FIRE DETECTION & ALARM SYSTEM SHALL BE DESIGNED & INSTALLED IN THIS SPACE BY A CERTIFIED FIRE ALARM CONTRACTOR.

FIRE ALARM CONTRACTOR SHALL SUBMIT FOR PERMIT & SHALL BE RESPONSIBLE FOR ALL REQUIRED INSPECTIONS.

CONSTRUCTION DRAWINGS OR SHOP DRAWINGS, OR BOTH, FOR THE INSTALLATION OF FIRE ALARM SYSTEMS SHALL BE SUBMITTED TO INDICATE CONFORMANCE TO SECTION 903.3.1.2 OF THE OBC & SHALL BE REVIEWED BY THE BUILDING DEPARTMENT PRIOR TO ISSUANCE OF A

FIRE ALARM CONTRACTOR SHALL COORDINATE DEVICE LOCATIONS W/THE ARCHITECT & TENANT. COORD. W/THE WALL CONSTRUCTION, CEILINGS & LIGHTING PLAN



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DATE:

FEBRUARY 14, 2023

REVISION DATES:

PROJECT:


VISTA COMMUNITY CHURCH
5626 FRANTZ RD.
DUBLIN, OHIO 43017

PROJECT NUMBER: CAI202175

SHEET TITLE:

### PLAN NOTES/CABINET ELEVATIONS

SHEET NUMBER:

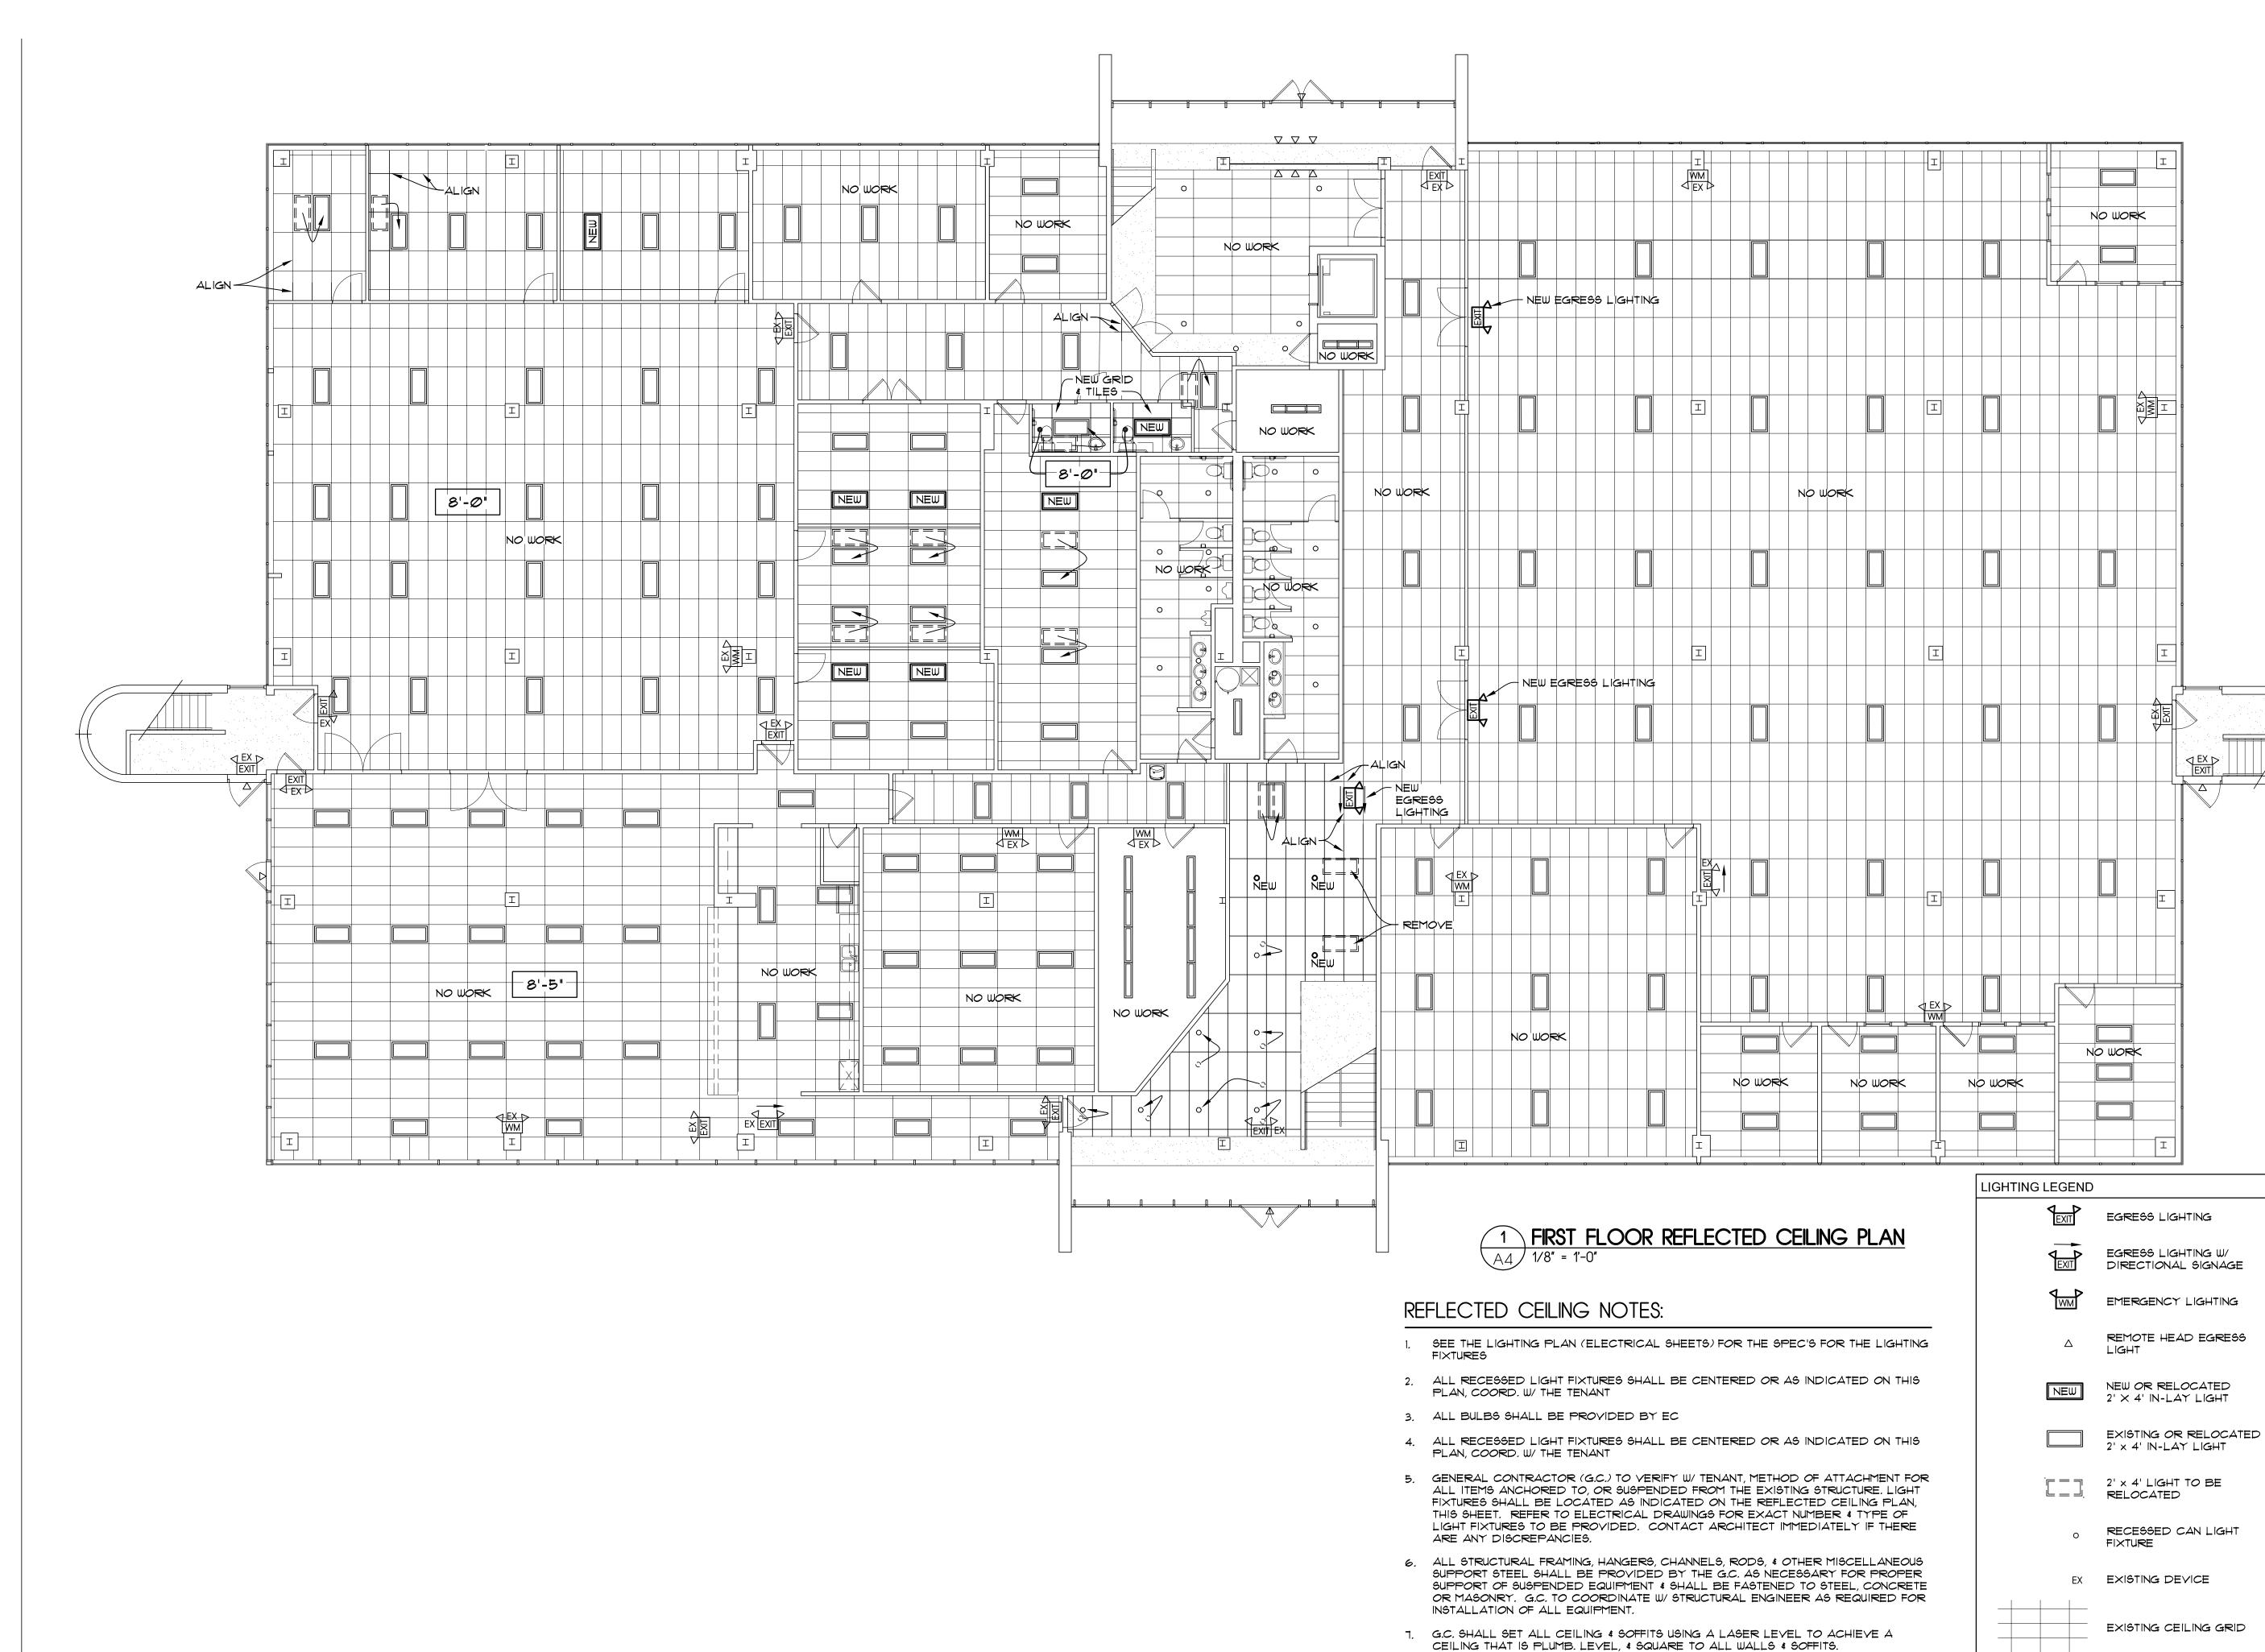

8. ALL NOTED CEILING DIMENSIONS ARE INDICATED AS CLEAR ABOVE FINISHED

IN ORDER TO ACHIEVE REQUIRED DIMENSIONS.

FIXTURES - COORD. W/ FIXTURE MANUFACTURER.

FLOOR DIMENSIONS. VERIFY THICKNESS OF FLOOR CONSTRUCTION W/FLOORING

9. G.C. TO PROVIDE NECESSARY BLOCKING & BRACING FOR FIXTURE INSTALLATION & ALL ELECTRICAL COMPONENTS TO COMPLETE THE FINAL INSTALLATION OF ALL

SUB-CONTRACTOR PRIOR TO INSTALLATION OF ANY NEW CEILING CONSTRUCTION

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VISTA COMMUNITY CHURCH
5626 FRANTZ RD.

PROJECT NUMBER: CAI202175

DUBLIN, OHIO 43017

SHEET TITLE:

FIRST FLOOR REFLECTED CEILING PLAN

SHEET NUMBER:

NEW CEILING GRID


×'-×"

GYPSUM BOARD CEILING

INDICATES THE HEIGHT OF

THE CEILING ABOVE THE


FINISH FLOOR

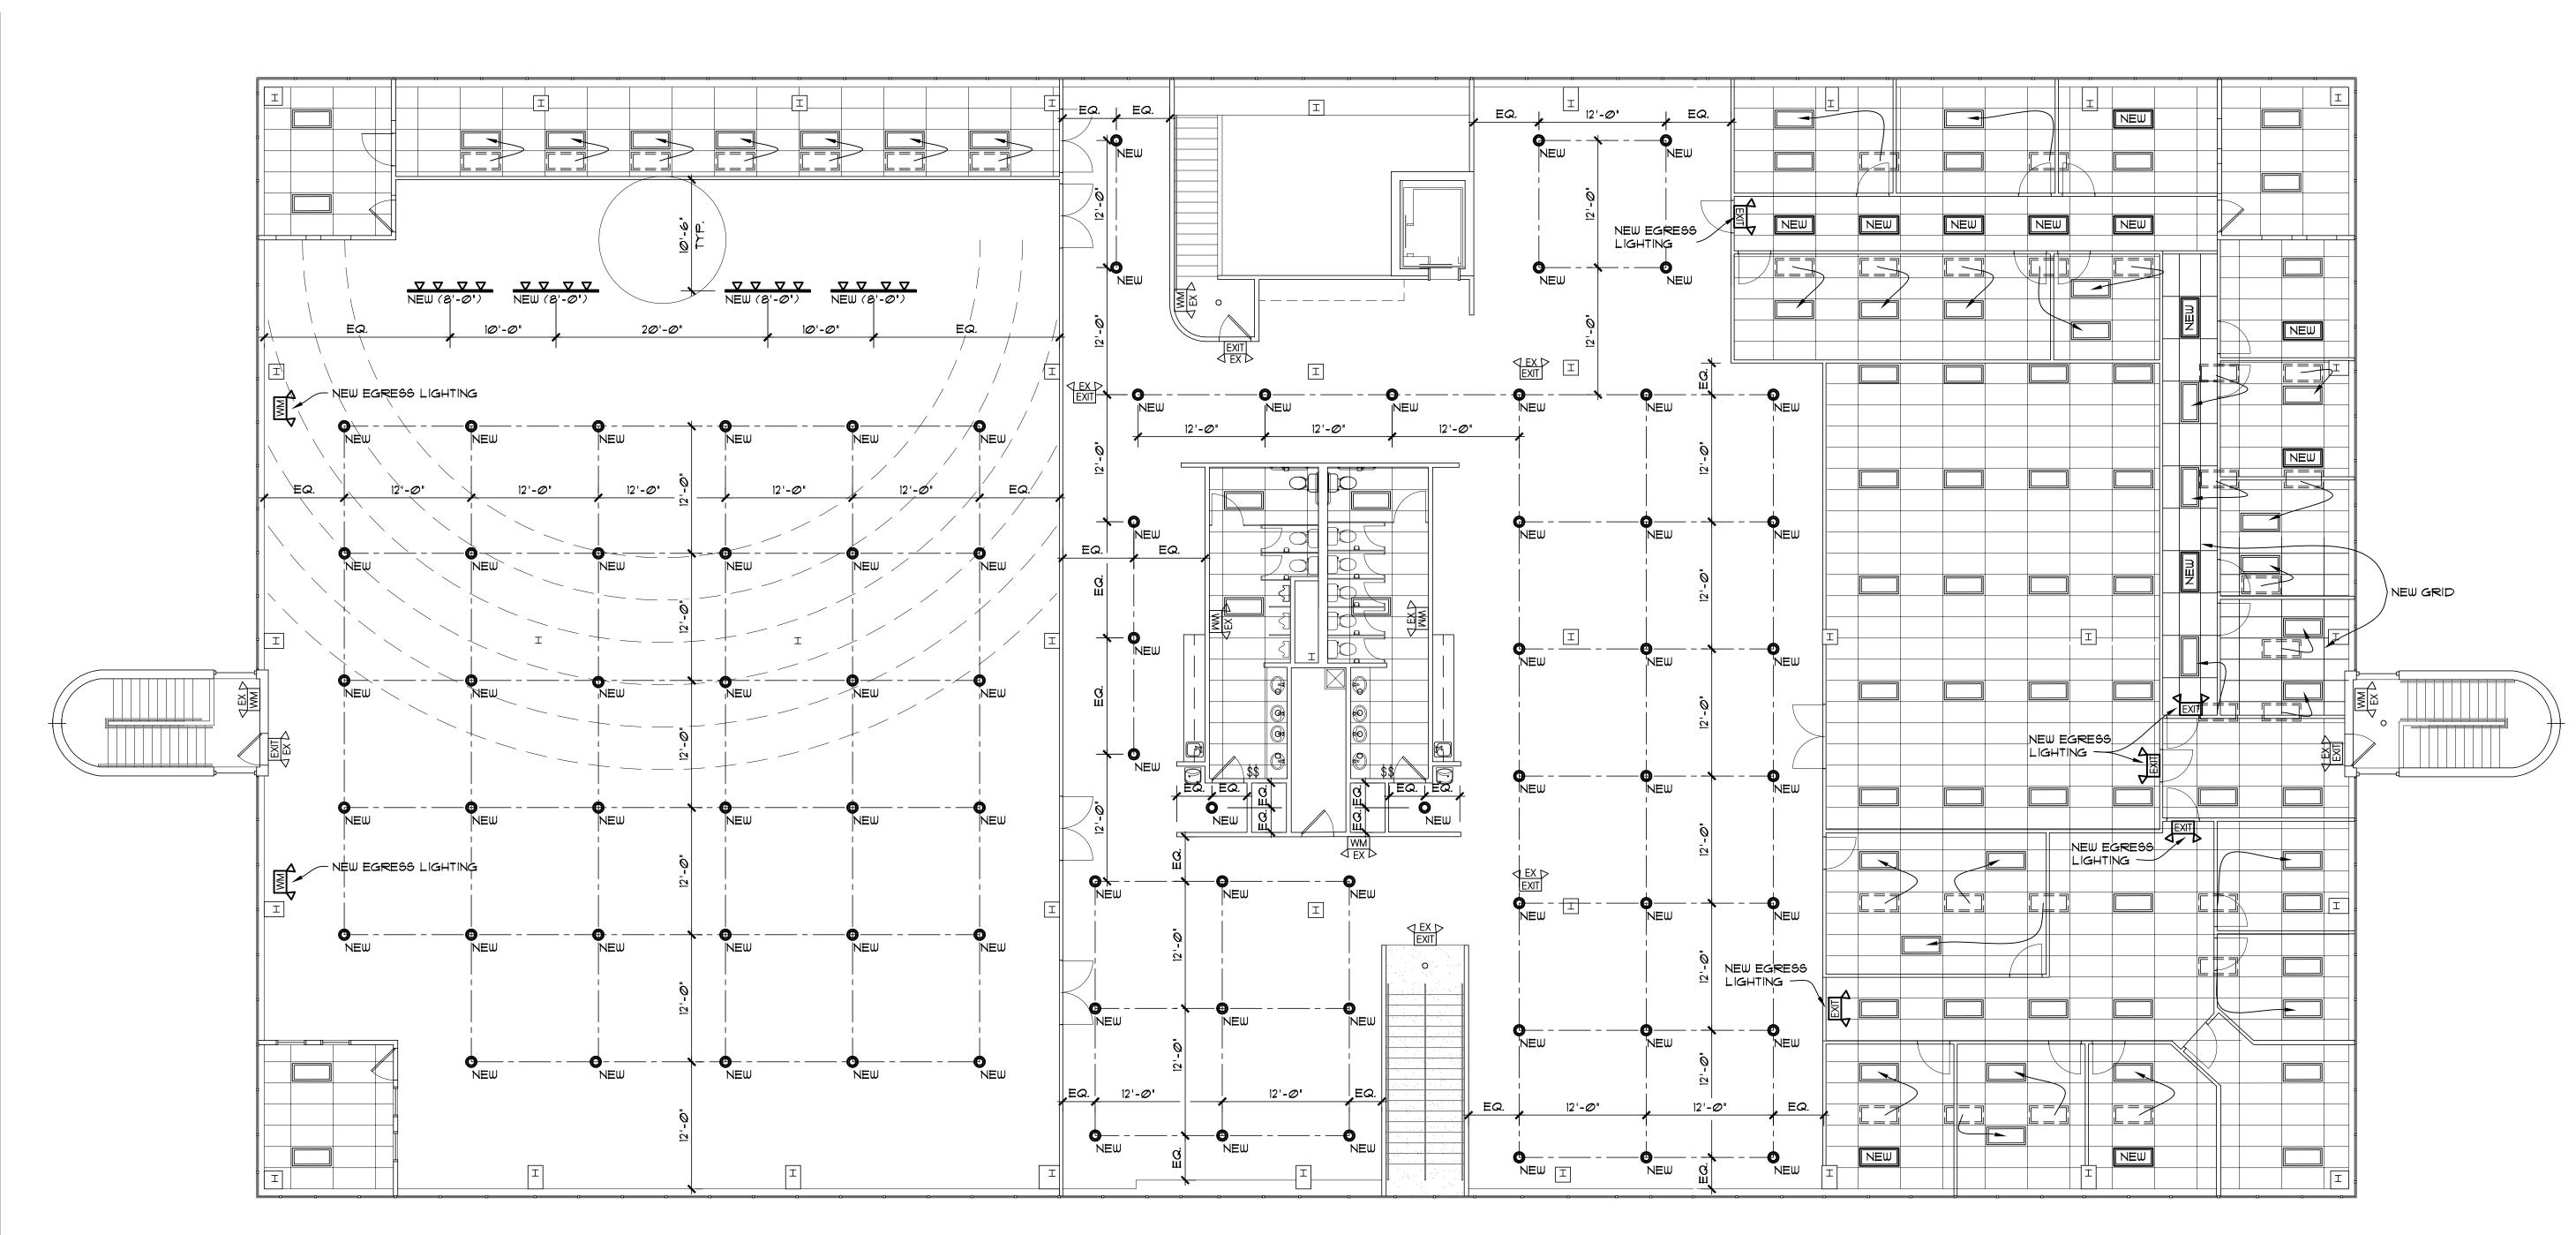

1 SECOND FLOOR REFLECTED CEILING PLAN
A5 1/8" = 1'-0"

### REFLECTED CEILING NOTES:

- 1. SEE THE LIGHTING PLAN (ELECTRICAL SHEETS) FOR THE SPEC'S FOR THE LIGHTING FIXTURES
- 2. ALL RECESSED LIGHT FIXTURES SHALL BE CENTERED OR AS INDICATED ON THIS PLAN, COORD. W/ THE TENANT
- 3. ALL BULBS SHALL BE PROVIDED BY EC
- 4. ALL RECESSED LIGHT FIXTURES SHALL BE CENTERED OR AS INDICATED ON THIS PLAN, COORD. W/ THE TENANT
- 5. GENERAL CONTRACTOR (G.C.) TO VERIFY W/ TENANT, METHOD OF ATTACHMENT FOR ALL ITEMS ANCHORED TO, OR SUSPENDED FROM THE EXISTING STRUCTURE. LIGHT FIXTURES SHALL BE LOCATED AS INDICATED ON THE REFLECTED CEILING PLAN, THIS SHEET. REFER TO ELECTRICAL DRAWINGS FOR EXACT NUMBER & TYPE OF LIGHT FIXTURES TO BE PROVIDED. CONTACT ARCHITECT IMMEDIATELY IF THERE ARE ANY DISCREPANCIES.
- 6. ALL STRUCTURAL FRAMING, HANGERS, CHANNELS, RODS, & OTHER MISCELLANEOUS SUPPORT STEEL SHALL BE PROVIDED BY THE G.C. AS NECESSARY FOR PROPER SUPPORT OF SUSPENDED EQUIPMENT & SHALL BE FASTENED TO STEEL, CONCRETE OR MASONRY. G.C. TO COORDINATE W/ STRUCTURAL ENGINEER AS REQUIRED FOR INSTALLATION OF ALL EQUIPMENT.
- 7. G.C. SHALL SET ALL CEILING & SOFFITS USING A LASER LEVEL TO ACHIEVE A CEILING THAT IS PLUMB. LEVEL, & SQUARE TO ALL WALLS & SOFFITS.
- 8. ALL NOTED CEILING DIMENSIONS ARE INDICATED AS CLEAR ABOVE FINISHED FLOOR DIMENSIONS. VERIFY THICKNESS OF FLOOR CONSTRUCTION W/ FLOORING SUB-CONTRACTOR PRIOR TO INSTALLATION OF ANY NEW CEILING CONSTRUCTION IN ORDER TO ACHIEVE REQUIRED DIMENSIONS.
- 9. G.C. TO PROVIDE NECESSARY BLOCKING & BRACING FOR FIXTURE INSTALLATION & ALL ELECTRICAL COMPONENTS TO COMPLETE THE FINAL INSTALLATION OF ALL FIXTURES COORD. W/ FIXTURE MANUFACTURER.

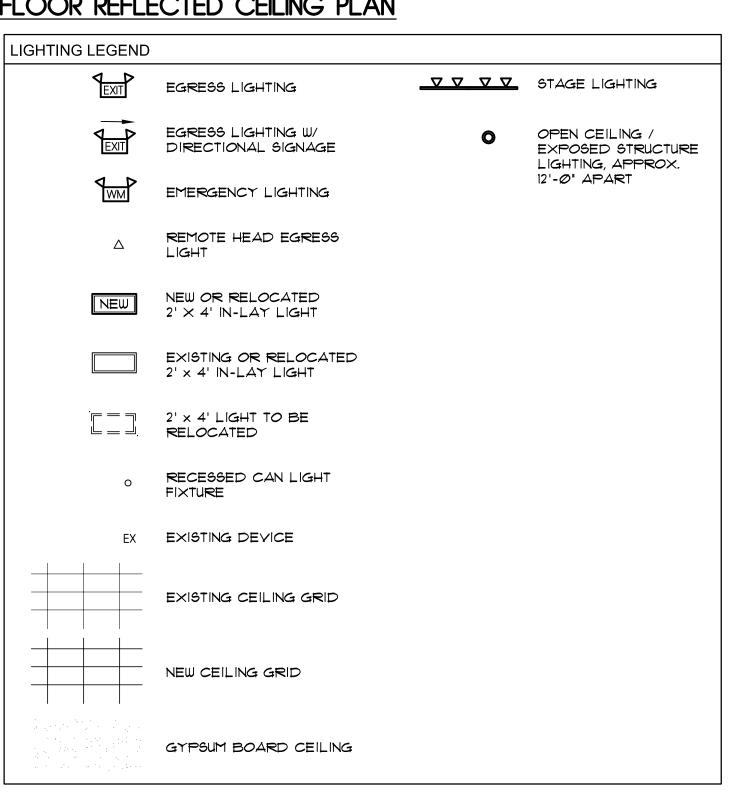



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VISTA COMMUNITY CHURCH
5626 FRANTZ RD.
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PROJECT NUMBER: CAI202175

SHEET TITLE:

SECOND FLOOR
REFLECTED CEILING PLAN

SHEET NUMBER:

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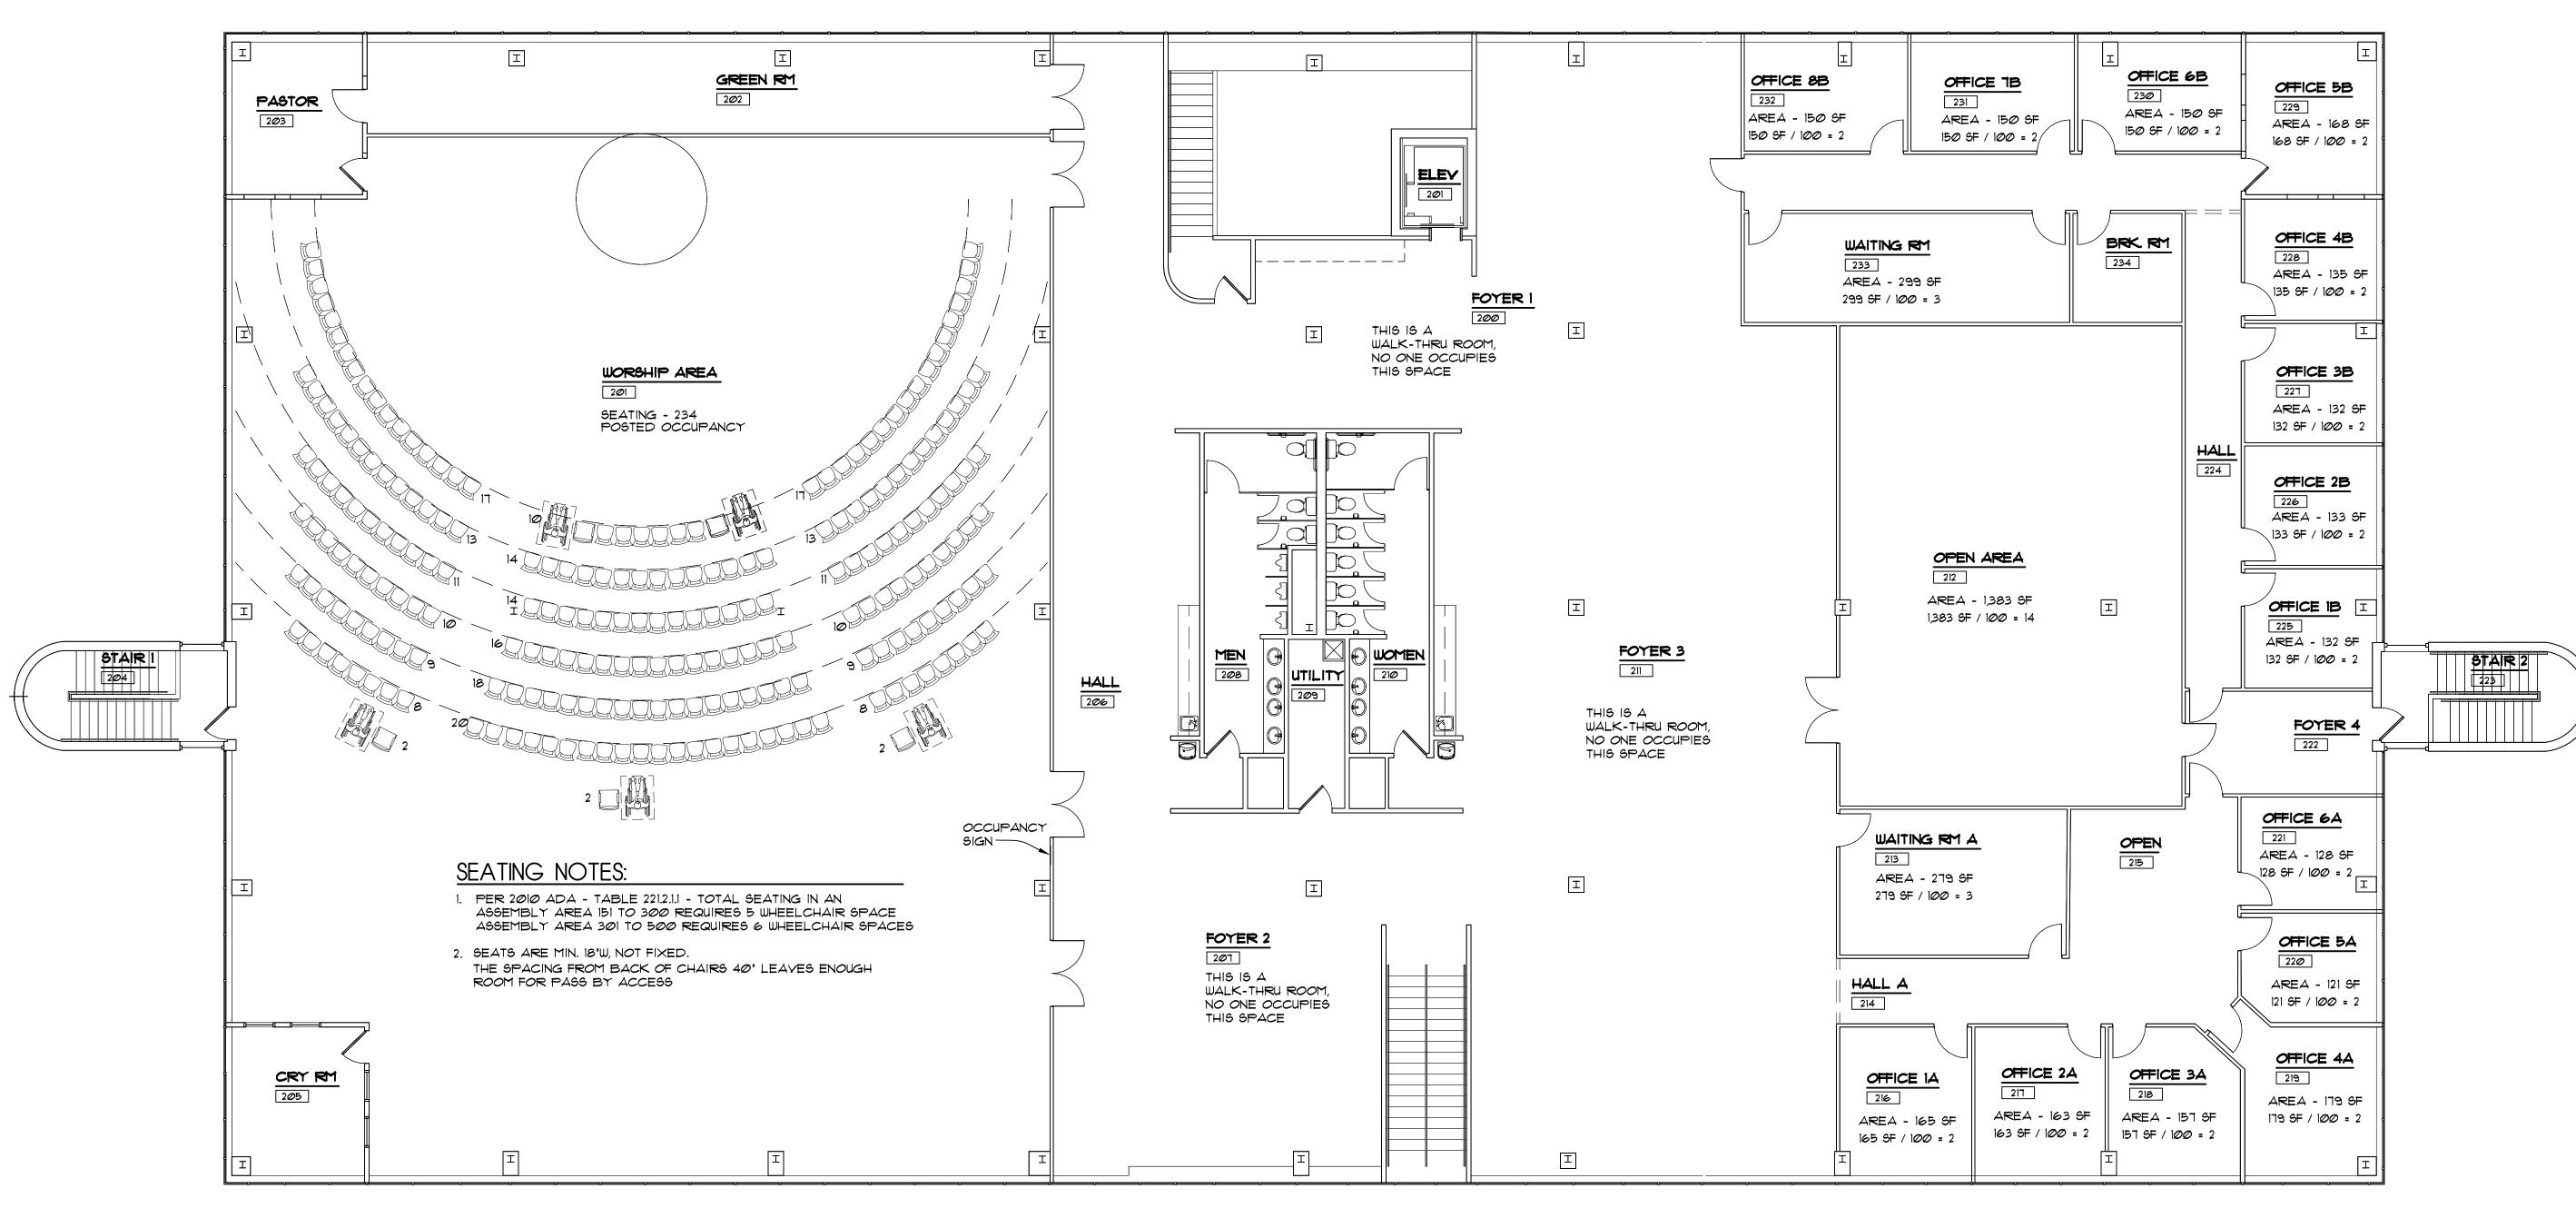
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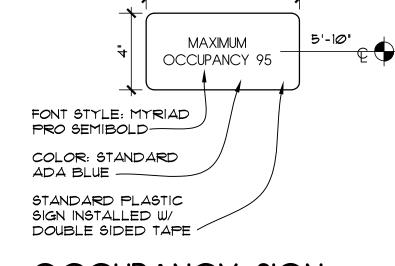
SHEET TITLE:

FIRST FLOOR OCCUPANCY PLAN

SHEET NUMBER:







OCCUPANCY SIGN

N.T.S.



FLOOR AREA: 20,667 SF

### SECOND FLOOR OCCUPANCY: OFFICE AREA - 4,024 SF: 41

WORSHIP AREA - 6,908 SF: 234

TOTAL OCCUPANCY: 275

### TOILET COUNT:

1. PER OBC - TABLE 2902.1 BUSINESS AREA - 1 PER 50, 2 TOILETS REQUIRED.
WORSHIP AREA - 1 PER 125 MEN, 1 PER 15 WOMEN
3 TOILETS REQUIRED
12 TOILET FIXTURES ARE EXISTING.



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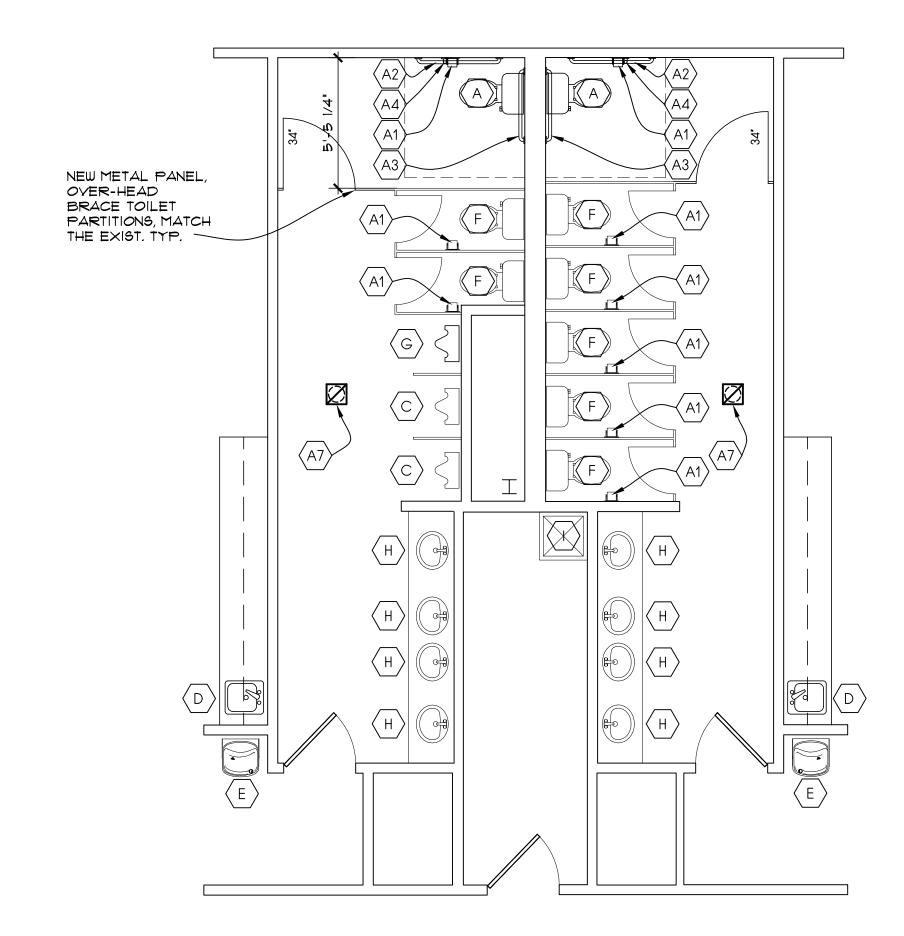
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SHEET TITLE:

SECOND FLOOR OCCUPANCY PLAN






# 2 SECOND FLOOR ENLARGED TOILET PLAN 1/4" = 1'-0"

### PLUMBING NOTES

- 1. TOILET FLUSH CONTROLS SHALL BE OPERABLE W/ ONE HAND & SHALL NOT REQUIRE TIGHT GRASPING, PINCHING, OR TWISTING OF THE WRIST. CONTROLS FOR THE FLUSH VALVES SHALL BE MOUNTED NO MORE THAN 44" ABOVE THE FLOOR, THE FORCE REQUIRED TO ACTIVATE CONTROLS SHALL BE NO GREATER THAN 5 LBS/FT.
- 2. A CLEAR FLOOR SPACE 30" WIDE BY 48" LONG SHALL BE PROVIDED IN FRONT OF THE LAVATORY TO ALLOW A FORWARDS APPROACH. SUCH CLEAR FLOOR SPACE SHALL ADJOIN OR OVERLAP AN ACCESSIBLE ROUTE & SHALL EXTEND INTO KNEE & TOE SPACE UNDERNEATH THE LAVATORY.
- 3. HOT WATER & DRAIN PIPES UNDER LAVATORIES SHALL BE INSULATED OR OTHERWISE COVERED. THERE SHALL BE NO SHARP OR ABRASIVE SURFACE UNDER
- 4. FAUCET CONTROLS & OPERATING MECHANISMS SHALL BE OPERABLE W/ ONE HAND & SHALL NOT REQUIRE TIGHT GRASPING, PINCHING OR TWISTING OF THE WRIST. THE FORCE REQUIRED TO ACTIVATE THE CONTROLS SHALL BE NO GREATER THAN 5 LBS/FT. LEVER PUSH-TYPE & ELECTRONICALLY CONTROLLED MECHANISMS ARE EXAMPLES OF ACCEPTABLE DESIGN, SELF CLOSING VALVES ARE ALLOWED IF THE FAUCETS REMAIN OPEN FOR AT LEAST 10 SECONDS.
- 5. FLUSH HANDLES SHALL BE ON THE WIDE SIDE OF ROOM IN ALL TOILET STALLS.
- 6. MIRRORS SHALL BE MOUNTED W/ BOTTOM EDGE NOT MORE THAN 40" FROM THE FLOOR.
- LOCATE TOILET TISSUE DISPENSERS ON THE WALL WITHIN 12" OF THE FRONT EDGE OF THE TOILET SEAT.
- 8. GRAB BARS, FASTENERS & MOUNTING DEVICES SHALL BE DESIGNED FOR 250 LBS./LINEAR FT. LOAD.
- 9. ALL GYP. BD. @ WET WALLS SHALL BE WATER RESISTANT, 8'-0" HIGH MIN., TYPE IN ALL RESTROOMS.
- 10. FIXTURES TYPE SPEC'ED ON PLUMBING DRAWINGS, COORDINATE W/ THE OWNER BEFORE ORDERING.
- PROVIDE A SIGN OUTSIDE OF EACH RESTROOM INDICATING THE SEX FOR EACH RESTROOM & THAT IT IS ADA COMPLIANT PER OBC 2902.2
   THE EQUIPMENT ROUGH-INS AS SHOWN ARE BASED UPON AVAILABLE INFORMATIC
- 12. THE EQUIPMENT ROUGH-INS AS SHOWN ARE BASED UPON AVAILABLE INFORMATION. HOWEVER, IN SOME INSTANCES, THE OWNER OR SUPPLIER MAY SUBSTITUTE OR THE EQUIPMENT ITEM MAY VARY FROM WHAT IS SHOWN, THEREFORE, THE CONTRACTOR SHALL VERIFY ALL CRITICAL DIMENSIONS W/ THE OWNER PRIOR TO CONSTRUCTION. FAILURE OF THE CONTRACTOR TO VERIFY THESE DIMENSIONS SHALL PLACE THE RESPONSIBILITY FOR ANY SUBSEQUENT RELOCATION DIRECTLY ON THE CONTRACTOR.
- 13. PROVIDE SOLID IN-WALL BLOCKING AS REQUIRED FOR ALL TOILET ACCESSORIES & CASEWORK, METAL STUDS OR FIRE TREATED WOOD BLOCKING.
- 14. THE ACCESSIBILITY SHEET IN THIS SET SHALL TAKE PRECEDENT OVER ALL OTHER SHEETS. SEE ACCESSIBILITY SHEET IN THIS SET FOR ALL REQUIREMENTS.
- 15. THE CONTRACTOR HAS THE RIGHT TO SUBSTITUTE THE MANUFACTURER OF THE PLUMBING ACCESSORIES AS LONG AS THE ACCESSORIES MEETS OR EXCEEDS THE DESIGN REQUIREMENTS AS INDICATED. PROVIDE CUT SHEETS TO THE ARCHITECT & OWNER FOR APPROVAL PRIOR TO SUBSTITUTION.
- 16. THE TOILET STALL COMPARTMENT DOORS SHALL BE GRASPABLE W/ THE REQUIRED CLOSER & SHALL HAVE A CLEAR OPENING OF 32" MIN.

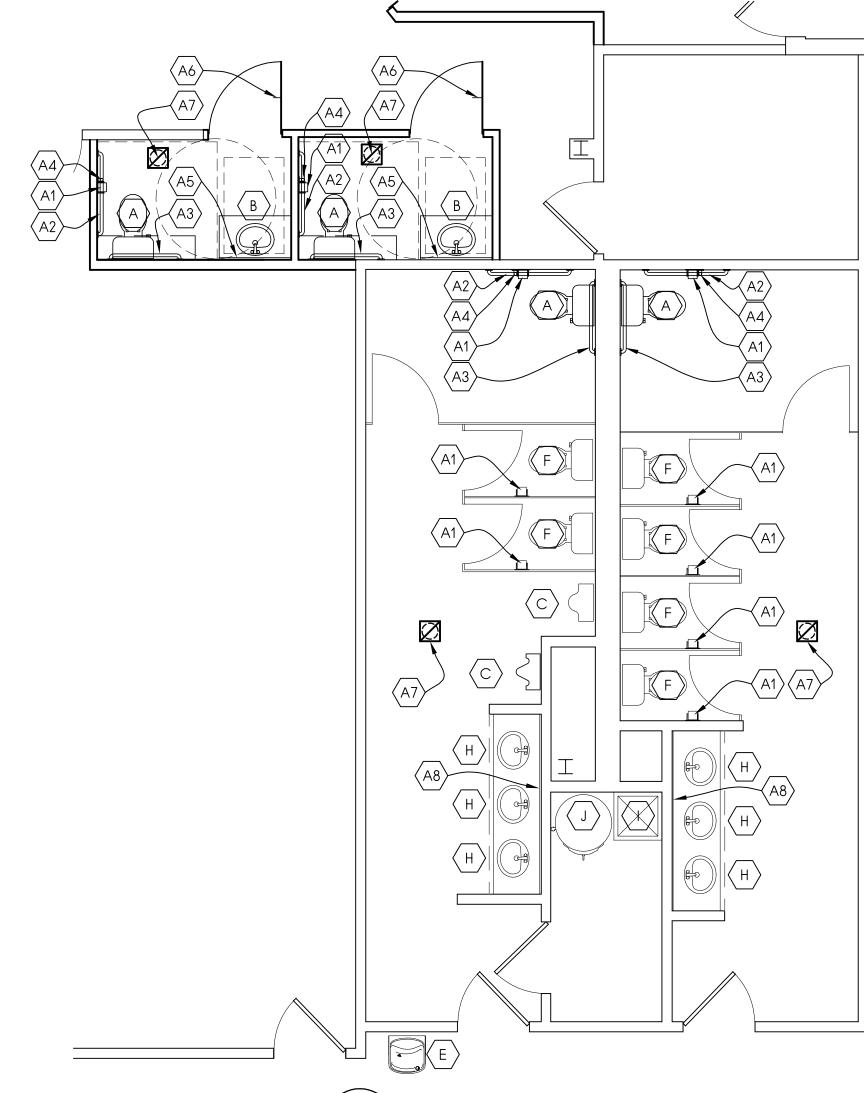

### 1 FIRST FLOOR ENLARGED TOILET PLAN

### PLLIMBING FIXTURE SCHEDULE

	PLUIVIDING FIXTURE SCHEDULE					
NO.	(*) DESCRIPTION					
А	ADA TOILET - SEE PLUMBING SHEETS					
В	ADA LAVATORY (COUNTER TOP) - SEE PLUMBING SHEET					
С	EXIST. URINAL - SEE PLUMBING SHEET					
D	BAR SINK - SEE PLUMBING SHEET					
Ш	EXIST. WATER FOUNTAIN - SEE PLUMBING SHEET					
F	EXIST. TOILETS - SEE PLUMBING SHEET					
G	ADA URINAL - SEE PLUMBING SHEETS					
Н	EXIST. LAV SEE PLUMBING SHEET					
ı	EXIST. MOP SINK - SEE PLUMBING SHEET					
J	EXIST. WATER HEATER - SEE PLUMBING SHEET					

### ACCESSORIES SCHEDULE

NO.	(#) DESCRIPTION	MOUNTING HEIGHT
A1	SURFACE MOUNTED TOILET TISSUE DISPENSER SINGLE ROLL - 36" MAX. FROM REAR WALL	TOP @ 2'-8" AFF
A2	42" GRAB BAR - MOUNT 12" AWAY FROM CORNER	€ @ 3'-0" AFF
А3	36" GRAB BAR - MOUNT 6" AWAY FROM CORNER	€ @ 3'-0" AFF
A4	18" GRAB BAR, VERTICAL - MOUNT 40" AWAY FROM CORNER @ & THE BOTTOM	BOTTOM @ 3'-4" AFF
A5	3'-0"W x 3'-6"H MIRROR	BOTTOM @ 3'-4" AFF, MAX.
A6	COAT HOOK	MOUNT CENTERLINE 48" AFF
A7	EXHAUST FAN - SEE MECH. SHEETS	CEILING MOUNTED
A8	EXIST. FULL WIDTH MIRROR	VERIFY BOTTOM @ 3'-4" AFF, MAX.
		<u> </u>

- \* ALTERNATE PLUMBING ACCESSORIES MAY BE SUBSTITUTED W/ OWNER APPROVAL
- \*\* ALL PLUMBING ACCESSORIES SHALL BE INSTALLED IN ACCORDANCE W/ MANUFACTURER'S SPECIFICATIONS.

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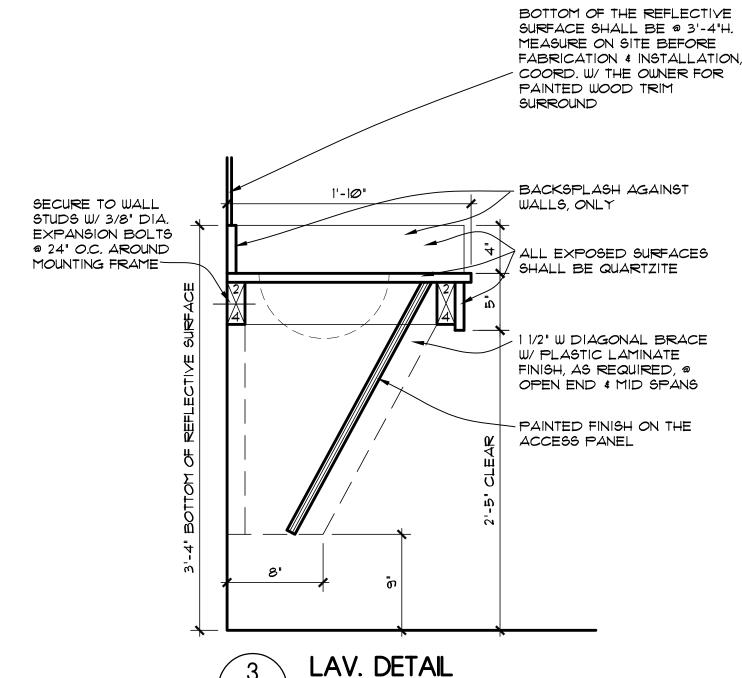
PROJECT NUMBER: CAI202175

SHEET TITLE:

ENLARGED TOILET PLANS/ DETAILS

SHEET NUMBER:

**A8** 



1 1/2" = 1'-0"

### GENERAL DOOR NOTES:

- 1. COORDINATE OPENINGS & FRAMING W/ CONTRACTOR BEFORE INSTALLATION OF DOORS
- 2. ALL INTERIOR DOORS SHALL BE WOOD, SOLID CORE, FLUSH PANEL, STAIN GRADE, UNLESS NOTED OTHERWISE. DOOR FINISH DETAILS SHALL BE SELECTED BY OWNER. THE DOOR FRAMES SHALL BE HOLLOW METAL. COORD. W/ OWNER BEFORE PURCHASING FROM MFR'S STANDARDS.
- 3. ALL HARDWARE SHALL COMPLY W/ THE LATEST REQUIREMENTS OF
- 4. ALL HARDWARE FINISH, MATERIAL, KEYING & FUNCTION SHALL BE COORDINATED W/ THE OWNER
- 7. SEE THE BLDG PLAN SHEETS FOR THE EXACT COUNT, SWING \$ LOCATION OF DOORS REQ'D
- 8. PROVIDE THREE SILENCERS ON ALL HM DOOR FRAMES INSTALLED ON LATCH SIDE OF FRAMES.
- CONTRACTOR SHALL COORD. ALL HARDWARE FUNCTION, SCHEDULE, PURPOSE, ETC. W/ OWNER BEFORE SHOP DRAWINGS, ORDERING & INSTALLATION.
- 10. ALL REQUIRED EXITS SHALL BE ACCESSIBLE & HAVE ACCESSIBLE HARDWARE
- 11. ALL MEANS OF EGRESS SHALL BE READILY OPERABLE FROM THE SIDE FROM WHICH EGRESS IS TO BE MADE WITHOUT THE USE OF A KEY OR SPECIAL KNOWLEDGE OR EFFORT. ALL OF THE ENTRY DOORS SHALL REMAIN UNLOCK WHEN THE SPACE IS OCCUPIED. THE EGRESS LOCKING DEVICE SHALL BE DISTINGUISHABLE AS LOCK OR UNLOCK OR THE LOCKING DEVICE SHALL ALWAYS BE UNLOCK FROM THE INSIDE.

- 12. PER OBC 1008.1.9.3: IN BUILDINGS IN OCCUPANCY GROUP "A" HAVING AN OCCUPANT LOAD OF 300 OR LESS, GROUPS "B", "F", "M", "S" AN IN CHURCHES, THE MAIN EXTERIOR DOOR OR DOORS IS PERMITTED TO BE EQUIPPED WITH KEY-OPERATED LOCKING DEVICES FROM THE EGRESS SIDE PROVIDED: A READILY VISIBLE DURABLE SIGN IS POSTED ON THE EGRESS SIDE ON OR ADJACENT TO THE DOOR STATING: "THIS DOOR TO REMAIN UNLOCKED WHEN BUILDING IS OCCUPIED", THE SIGN SHALL BE LETTERS I" HIGH ON A CONTRASTING BACKGROUND.
- 13. ALL OF THE ENTRY DOORS SHALL REMAIN UNLOCK WHEN THE SPACE IS OCCUPIED. THE EGRESS LOCKING DEVICE SHALL BE DISTINGUISHABLE AS LOCK OR UNLOCK OR THE LOCKING DEVICE SHALL ALWAYS BE UNLOCK FROM THE INSIDE OR PANIC HARDWARE EXISTING EGRESS DOOR HAVE PANIC HARDWARE
- 14. INTERIOR HM FRAMES SHALL BE 16 GA. WRAP AROUND, WELDED OR KNOCK DOWN TYPE
- 15. THE CONTRACTOR HAS THE RIGHT TO SUBSTITUTE THE MANUFACTURER OF THE HARDWARE AS LONG AS THE HARDWARE MEETS OR EXCEEDS THE DESIGN REQUIREMENTS AS INDICATED. PROVIDE CUT SHEETS TO THE OWNER FOR APPROVAL PRIOR TO SUBSTITUTION.
- 16. ANY EXIST. DOOR & FRAME BEING REMOVED, MAY BE REUSED IF IN GOOD CONDITION, COORD. W/ THE OWNER

### HARDWARE MFG.

HINGES: EQUAL


HAGER CO., BB1279, 4 1/2" OR APPROVED

LEVERS:


SCHLAGE, D SERIES, ATHENS STYLE MODEL\* 606 OR APPROVED EQUAL

### HARDWARE KEY


- A. 11/2 PR. HEAVY DUTY BALL BEARING HINGES
- B. CLOSER
- C. OFFICE LOCK SET LEVER
- D. PASSAGE LATCH SET LEVER
- E. DOOR STOP WALL MOUNTED
- F. PRIVACY LOCK SET LEVER
- G. PANIC BAR, EGRESS HARDWARE

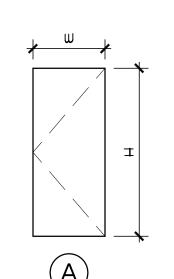




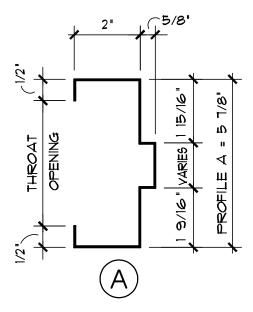

1 DOOR ELEV. 2 FRAME PROFILES A9 N.T.S.

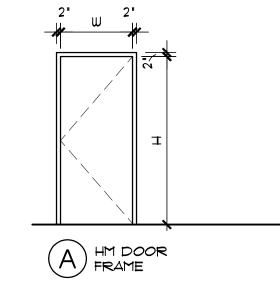

3 FRAME ELEVATIONS \A9/1/4" = 1'-0"

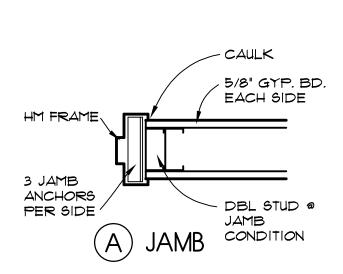

4 DETAILS A9/11/2" = 1'-0"

No.	DOOR REMARKS
N1	EXIST. ALUM DOOR & FRAME, VERIFY IN GOOD CONDITION FOR REUSE. EXIST. PUSH BAR EXIT. IF REQUIRED, REPLACE SAME SIZE
N2	EXIST. WOOD DOOR W/ HM FRAME VERIFY IN GOOD CONDITION FOR REUSE, EXIST. PANIC HARDWARE, IF REQUIRED REBASE TO MATCH
N3	EXIST. WOOD DR & HM FRAME, VERIFY IN GOOD CONDITION FOR REUSE W/ HARDWARE
N4	EXIST. WOOD DR & WOOD FRAME, VERIFY IN GOOD CONDITION FOR REUSE
N5	
N6	

### DOOR HARDWARE & FRAME SCHEDULE

NO.	DOOR SIZE	MATERIAL	ELEV	RATING	HARDWARE	FRAME MATERIAL	PROFILE	ELEVATION	DETAILS	REMARKS
100A	PR 3'-0" x 7'-0" x 1 3/4"	ALUM			EXISTING	ALUM		LLLVATION		N1
100A 100B	PR 3'-0" x 7'-0" x 1 3/4"	WOOD	1A/A9	1 HR	A,B,E,G	HM	2A/A9	3A/A9	4A/A9	INI
100C	PR 3'-0" x 7'-0" x 1 3/4"	WOOD		1 HR	EXISTING	HM			-7,0,7,7	N2, RELOCATED
102A	3'-0" x 7'-0" x 1 3/4"	НМ		1 HR	EXISTING	HM				N2
104A	3'-0" x 7'-0" x 1 3/4"	WOOD			EXISTING	HM				N3
105A	3'-0" x 7'-0" x 1 3/4"	WOOD	1A/A9		A,B,F	HM	2A/A9	3A/A9	4A/A9	
106A 107A	3'-0" x 7'-0" x 1 3/4" 3'-0" x 7'-0" x 1 3/4"	WOOD	1A/A9 		A,B,F EXISTING	HM HM	2A/A9	3A/A9 	4A/A9	N3
107A 107B	3'-0" x 7'-0" x 1 3/4"	WOOD			EXISTING	HM				N3
108A	PR 3'-0" x 7'-0" x 1 3/4"	WOOD			EXISTING	HM				N3
109A	3'-0" x 7'-0" x 1 3/4"	WOOD			EXISTING	HM				N3
110A	3'-0" x 7'-0" x 1 3/4"	WOOD			EXISTING	HM			44.440	N3
111A 112A	3'-0" x 7'-0" x 1 3/4" 3'-0" x 7'-0" x 1 3/4"	WOOD	1A/A9 1A/A9		A,D,E A,D,E	HM HM	2A/A9 2A/A9	3A/A9 3A/A9	4A/A9 4A/A9	
113A	3'-0" x 7'-0" x 1 3/4"	WOOD	1A/A9		A,C,E	HM	2A/A9	3A/A9	4A/A9	
114A	3'-0" x 7'-0" x 1 3/4"	WOOD			EXISTING	HM				N3
114B	3'-0" x 7'-0" x 1 3/4"	WOOD			EXISTING	НМ				N3
114C	PR 3'-0" x 7'-0" x 1 3/4"	WOOD	1A/A9		A,D,E	HM	2A/A9	3A/A9	4A/A9	
114D 115A	PR 3'-0" x 7'-0" x 1 3/4" 3'-0" x 7'-0" x 1 3/4"	WOOD	1A/A9 1A/A9		A,D,E A,D,E	HM HM	2A/A9 2A/A9	3A/A9 3A/A9	4A/A9 4A/A9	
116A	3'-0" x 7'-0" x 1 3/4"	WOOD	1A/A9		A,D,E	HM	2A/A9	3A/A9	4A/A9	
117A	3'-0" x 7'-0" x 1 3/4"	WOOD		1 HR	EXISTING	HM				N3
117B	3'-0" x 7'-0" x 1 3/4"	ALUM			EXISTING	ALUM				N1
118A	3'-0" x 7'-0" x 1 3/4"	ALUM		4.115	EXISTING	ALUM				N1
118B	3'-0" x 7'-0" x 1 3/4"	WOOD		1 HR	EXISTING	HM				N2 N3
118C 118D	3'-0" x 7'-0" x 1 3/4" 3'-0" x 7'-0" x 1 3/4"	WOOD			EXISTING EXISTING	HM HM				N3
120A	3'-0" x 7'-0" x 1 3/4"	WOOD			EXISTING	HM				N3
122A	3'-0" x 7'-0" x 1 3/4"	WOOD			EXISTING	HM				N3
123A	3'-0" x 7'-0" x 1 3/4"	WOOD			EXISTING	HM				
124A 125A	3'-0" x 7'-0" x 1 3/4" 3'-0" x 7'-0" x 1 3/4"	WOOD			EXISTING EXISTING	HM HM				N3
126A	3'-0" x 7'-0" x 1 3/4"	WOOD			EXISTING	HM				N3
127A	PR 3'-0" x 7'-0" x 1 3/4"	ALUM			EXISTING	ALUM				N1
128A	3'-0" x 7'-0" x 1 3/4"	WOOD			EXISTING	НМ				N3
129A	PR 3'-0" x 7'-0" x 1 3/4"	WOOD			A,C,E	HM	2A/A9	3A/A9	4A/A9	
129B 130A	PR 3'-0" x 7'-0" x 1 3/4" 3'-0" x 7'-0" x 1 3/4"	WOOD			A,C,E EXISTING	HM HM	2A/A9	3A/A9 	4A/A9	N3
130B	3'-0" x 7'-0" x 1 3/4"	WOOD			EXISTING	HM				N3
131A	3'-0" x 7'-0" x 1 3/4"	WOOD			EXISTING	HM				N3
132A	3'-0" x 7'-0" x 1 3/4"	WOOD			EXISTING	НМ				N3
133A	3'-0" x 7'-0" x 1 3/4"	WOOD			EXISTING	HM				N3
134A	3'-0" x 7'-0" x 1 3/4" 3'-0" x 7'-0" x 1 3/4"	WOOD		1 HR	EXISTING EXISTING	HM				N3 N2
135A 135B	3'-0" x 7'-0" x 1 3/4"	ALUM		I I IIX	EXISTING	ALUM				N1
136A	3'-0" x 7'-0" x 1 3/4"	WOOD			EXISTING	НМ				N3
	0, 0, 7, 0, 4, 0, 4,	1440.00			EVIOTING.	\\\\\\\\\\\\\\\\\\\\\\\\\\\\\\\\\\\\\\				NO
200A 201A	3'-0" x 7'-0" x 1 3/4" PR 3'-0" x 7'-0" x 1 3/4"	WOOD	1A/A9		EXISTING A,D,E	WOOD	2A/A9	3A/A9	4A/A9	N3
201A 201B	PR 3'-0" x 7'-0" x 1 3/4"	WOOD	1A/A9		A,D,E	HM	2A/A9	3A/A9	4A/A9	
201C	PR 3'-0" x 7'-0" x 1 3/4"	WOOD	1A/A9		A,D,E	НМ	2A/A9	3A/A9	4A/A9	
202A	PR 3'-0" x 7'-0" x 1 3/4"	WOOD	1A/A9		A,D,E	HM	2A/A9	3A/A9	4A/A9	
203A	3'-0" x 7'-0" x 1 3/4"	WOOD			EXISTING	WOOD			40.400	N4
203B 204A	3'-0" x 7'-0" x 1 3/4" 3'-0" x 7'-0" x 1 3/4"	WOOD		1 HR	A,D,E EXISTING	HM HM	2A/A9	3A/A9 	4A/A9	N2
204A 205A	3'-0" × 7'-0" × 1 3/4"	WOOD			EXISTING	WOOD				N4
208A	3'-0" x 7'-0" x 1 3/4"	WOOD			EXISTING	WOOD				N4
209A	3'-0" × 7'-0" × 1 3/4"	WOOD			EXISTING	WOOD				N4
210A 212A	3'-0" x 7'-0" x 1 3/4" PR 3'-0" x 7'-0" x 1 3/4"	WOOD	1A/A9		EXISTING A C F	WOOD	2A/A9	3A/A9	4A/A9	N4
212A 212B	3'-0" x 7'-0" x 1 3/4"	WOOD	1A/A9		A,C,E A,C,E	HM	2A/A9 2A/A9	3A/A9 3A/A9	4A/A9 4A/A9	
213A	3'-0" x 7'-0" x 1 3/4"	WOOD			A,D,E	HM	2A/A9	3A/A9	4A/A9	
213B	3'-0" x 7'-0" x 1 3/4"	WOOD			A,D,E	НМ	2A/A9	3A/A9	4A/A9	
215A	3'-0" x 7'-0" x 1 3/4"	WOOD	1A/A9		A,C,E	HM	2A/A9	3A/A9	4A/A9	
216A 217A	3'-0" x 7'-0" x 1 3/4" 3'-0" x 7'-0" x 1 3/4"	ALUM WOOD	1A/A9 1A/A9		A,C,E A,C,E	HM HM	2A/A9 2A/A9	3A/A9 3A/A9	4A/A9 4A/A9	
217A 218A	3'-0" x 7'-0" x 1 3/4"	WOOD	1A/A9		A,C,E A,C,E	HM	2A/A9 2A/A9	3A/A9 3A/A9	4A/A9	
219A	3'-0" x 7'-0" x 1 3/4"	WOOD	1A/A9		A,C,E	НМ	2A/A9	3A/A9	4A/A9	
220A	3'-0" x 7'-0" x 1 3/4"	WOOD	1A/A9		A,C,E	HM	2A/A9	3A/A9	4A/A9	
221A	3'-0" x 7'-0" x 1 3/4"	WOOD	1A/A9	4.110	A,C,E	HM	2A/A9	3A/A9	4A/A9	NO
222A 224A	3'-0" x 7'-0" x 1 3/4" 3'-0" x 7'-0" x 1 3/4"	WOOD	1A/A9	1 HR	EXISTING A,C,E	HM HM	2A/A9	3A/A9	4A/A9	N2
224A 224B	3'-0" x 7'-0" x 1 3/4"	WOOD	1A/A9		A,C,E A,C,E	HM	2A/A9 2A/A9	3A/A9 3A/A9	4A/A9	
225A	3'-0" x 7'-0" x 1 3/4"	WOOD	1A/A9		A,C,E	HM	2A/A9	3A/A9	4A/A9	
226A	3'-0" x 7'-0" x 1 3/4"	WOOD	1A/A9		A,C,E	НМ	2A/A9	3A/A9	4A/A9	
227A	3'-0" x 7'-0" x 1 3/4"	WOOD	1A/A9		A,C,E	HM	2A/A9	3A/A9	4A/A9	
228A 229A	3'-0" x 7'-0" x 1 3/4" 3'-0" x 7'-0" x 1 3/4"	WOOD	1A/A9		A,C,E EXISTING	HM HM	2A/A9	3A/A9	4A/A9	N4
230A	3'-0" x 7'-0" x 1 3/4"	WOOD	1A/A9		A,C,E	HM	2A/A9	3A/A9	4A/A9	
231A	3'-0" × 7'-0" × 1 3/4"	WOOD	1A/A9		A,C,E	НМ	2A/A9	3A/A9	4A/A9	
232A	3'-0" × 7'-0" × 1 3/4"	WOOD	1A/A9		A,C,E	HM	2A/A9	3A/A9	4A/A9	
233A	3'-0" x 7'-0" x 1 3/4"	WOOD	1A/A9		A,C,E	HM	2A/A9	3A/A9	4A/A9	
233B 234A	3'-0" x 7'-0" x 1 3/4" 3'-0" x 7'-0" x 1 3/4"	WOOD	1A/A9 1A/A9		A,C,E A,C,E	HM HM	2A/A9 2A/A9	3A/A9 3A/A9	4A/A9 4A/A9	
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FEBRUARY 14, 2023

DATE:

REVISION DATES:

PROJECT:

VISTA COMMUNITY CHURCH 5626 FRANTZ RD. DUBLIN, OHIO 43017

PROJECT NUMBER: CAI202175

SHEET TITLE:

DOOR SCHEDULE/NOTES

### 1. GRAB BARS

GENERAL: ALL HANDRAILS, GRAB BARS, & TUB & SHOWER SEATS REQUIRED TO BE ACCESSIBLE SHALL COMPLY W/ ANSI.

SIZE & SPACING OF GRAB BARS & HANDRAILS: THE DIAMETER OR WIDTH OF THE GRIPPING SURFACES OF A HANDRAIL OR GRAB BAR SHALL BE 1-1/4" TO 1-1/2", OR THE SHAPE SHALL PROVIDE AN EQUIVALENT GRIPPING SURFACE. IF HANDRAILS OR GRAB BARS ARE MOUNTED ADJACENT TO A WALL, THE SPACE BETWEEN THE WALL & THE GRAB BAR SHALL BE 1-1/2". HANDRAILS MAY BE LOCATED IN A RECESS IF THE RECESS IS A MAXIMUM OF 3" & EXTENDS AT LEAST IS" ABOVE THE TOP OF THE RAIL.

STRUCTURAL STRENGTH: THE STRUCTURAL STRENGTH OF GRAB BARS, TUB 4 SHOWER SEATS, FASTENERS, & MOUNTING DEVICES SHALL MEET THE FOLLOWING SPECIFICATION: (1) BENDING STRESS IN A GRAB BAR OR SEAT INDUCED BY THE MAXIMUM BENDING MOMENT FROM THE APPLICATION OF 250 LBF SHALL BE LESS THAN THE ALLOWABLE STRESS FOR THE MATERIAL OF THE GRAB BAR OR SEAT. (2) SHEAR STRESS INDUCED IN A GRAB BAR OR SEAT BY THE APPLICATION OF 250 LBF SHALL BE LESS THAN THE ALLOWABLE SHEAR STRESS FOR THE MATERIAL OF THE GRAB BAR OR SEAT. IF THE CONNECTION BETWEEN THE GRAB BAR OR SEAT & ITS MOUNTING BRACKET OR OTHER SUPPORT IS CONSIDERED TO BE FULLY RESTRAINED, THEN DIRECT & TORSIONAL SHEAR STRESSES SHALL BE TOTALED FOR THE COMBINED SHEAR STRESS, WHICH SHALL NOT EXCEED THE ALLOWABLE SHEAR STRESS. (3) SHEAR FORCE INDUCED IN A FASTENER OR MOUNTING DEVICE FROM THE APPLICATION OF 250 LBF SHALL BE LESS THAN THE ALLOWABLE LATERAL LOAD OF EITHER THE FASTENER OR MOUNTING DEVICE OR THE SUPPORTING STRUCTURE, WHICHEVER IS THE SMALLER ALLOWABLE LOAD. (4) TENSILE FORCE INDUCED IN A FASTENER BY A DIRECT TENSION FORCE OF 250 LBF PLUS THE MAXIMUM MOMENT FROM THE APPLICATION OF 250 LBF SHALL BE LESS THAN THE ALLOWABLE WITHDRAWAL LOAD BETWEEN THE FASTENER & THE SUPPORTING STRUCTURE. (5) GRAB BARS SHALL NOT ROTATE WITHIN THEIR FITTINGS.

ELIMINATING HAZARDS: A HANDRAIL OR GRAB BAR & ANY WALL OR OTHER SURFACE ADJACENT TO IT SHALL BE FREE OF ANY SHARP OR ABRASIVE ELEMENTS. EDGES SHALL HAVE A MINIMUM RADIUS OF 1/8".

### 2. PROTRUDING OBJECTS:

GENERAL: OBJECTS PROJECTING FROM WALLS (FOR EXAMPLE, TELEPHONES) WITH THEIR LEADING EDGES BETWEEN 27 IN AND 80 IN ABOVE THE FINISHED FLOOR SHALL PROTRUDE NO MORE THAN 4 IN INTO WALKS, HALLS, CORRIDORS, PASSAGEWAYS, OR AISLES. OBJECTS MOUNTED WITH THEIR LEADING EDGES AT OR BELOW 27 IN ABOVE THE FINISHED FLOOR MAY PROTRUDE ANY AMOUNT. FREESTANDING OBJECTS MOUNTED ON POSTS OR PYLONS MAY OVERHANG 12 IN MAXIMUM FROM 27 IN TO 80 IN ABOVE THE GROUND OR FINISHED FLOOR. PROTRUDING OBJECTS SHALL NOT REDUCE THE CLEAR WIDTH OF AN ACCESSIBLE ROUTE OR MANEUVERING SPACE.

HEAD ROOM: WALKS, HALLS, CORRIDORS, PASSAGEWAYS, AISLES, OR OTHER CIRCULATION SPACES SHALL HAVE 80 IN MINIMUM CLEAR HEAD ROOM. IF VERTICAL CLEARANCE OF AN AREA ADJOINING AN ACCESSIBLE ROUTE IS REDUCED TO LESS THAN 80 IN (NOMINAL DIMENSION), A BARRIER TO WARN BLIND OR VISUALLY-IMPAIRED PERSONS SHALL BE PROVIDED.

### 3. SPACE ALLOWANCE AND REACH RANGES:

WHEELCHAIRS TO PASS IS 60 IN.

WHEELCHAIR PASSAGE WIDTH: THE MINIMUM CLEAR WIDTH FOR SINGLE WHEELCHAIR PASSAGE SHALL BE 32 IN AT A POINT AND 36 IN CONTINUOUSLY WIDTH FOR WHEELCHAIR PASSING. THE MINIMUM WIDTH FOR TWO

WHEELCHAIR TURNING SPACE: THE SPACE REQUIRED FOR A WHEELCHAIR TO MAKE A 180-DEGREE TURN IS A CLEAR SPACE OF 60 IN DIAMETER OR A T-SHAPED SPACE

CLEAR FLOOR OR GROUND SPACE FOR WHEELCHAIRS: SIZE AND APPROACH, THE MINIMUM CLEAR FLOOR OR GROUND SPACE REQUIRED TO ACCOMMODATE A SINGLE, STATIONARY WHEELCHAIR AND OCCUPANT IS 30 IN BY 48 IN. THE MINIMUM CLEAR FLOOR OR GROUND SPACE FOR WHEELCHAIRS MAY BE POSITIONED FOR FORWARD OR PARALLEL APPROACH TO AN OBJECT. CLEAR FLOOR OR GROUND SPACE FOR WHEELCHAIRS MAY BE PART OF THE KNEE SPACE REQUIRED UNDER SOME OBJECTS.

RELATIONSHIP OF MANEUVERING CLEARANCE TO WHEELCHAIR SPACES: ONE FULL UNOBSTRUCTED SIDE OF THE CLEAR FLOOR OR GROUND SPACE FOR A WHEELCHAIR SHALL ADJOIN OR OVERLAP AN ACCESSIBLE ROUTE OR ADJOIN ANOTHER WHEELCHAIR CLEAR FLOOR SPACE. IF A CLEAR FLOOR SPACE IS LOCATED IN AN ALCOVE OR OTHERWISE CONFINED ON ALL OR PART OF THREE SIDES.

<u>SURFACES FOR WHEELCHAIR SPACES:</u> CLEAR FLOOR OR GROUND SPACES FOR WHEELCHAIRS SHALL COMPLY WITH 4.5. FORWARD REACH, IF THE CLEAR FLOOR SPACE ONLY ALLOWS FORWARD APPROACH TO AN OBJECT, THE MAXIMUM HIGH FORWARD REACH ALLOWED SHALL BE 48 IN THE MINIMUM LOW FORWARD REACH IS 15 IN. IF THE HIGH FORWARD REACH IS OVER AN OBSTRUCTION.

SIDE REACH: IF THE CLEAR FLOOR SPACE ALLOWS PARALLEL APPROACH BY A PERSON IN A WHEELCHAIR, THE MAXIMUM HIGH SIDE REACH ALLOWED SHALL BE 54 IN AND THE LOW SIDE REACH SHALL BE NO LESS THAN 9 IN ABOVE THE FLOOR.

### 4. GROUND AND FLOOR SURFACES:

GENERAL: GROUND AND FLOOR SURFACES ALONG ACCESSIBLE ROUTES AND IN ACCESSIBLE ROOMS AND SPACES INCLUDING FLOORS, WALKS, RAMPS, STAIRS, AND CURB RAMPS, SHALL BE STABLE, FIRM, SLIP-RESISTANT.

CHANGES IN LEVEL: CHANGES IN LEVEL UP TO 1/4 IN MAY BE VERTICAL AND WITHOUT EDGE TREATMENT. CHANGES IN LEVEL BETWEEN 1/4 IN AND 1/2 SHALL BE BEVELED WITH A SLOPE NO GREATER THAN 1:2. CHANGES IN LEVEL GREATER THAN 1/2 IN SHALL BE ACCOMPLISHED BY MEANS OF A

CARPET: IF CARPET OR CARPET TILE IS USED ON A GROUND OR FLOOR SURFACE, THEN IT SHALL BE SECURELY ATTACHED, HAVE A FIRM CUSHION, PAD, OR BACKING, OR NO CUSHION OR PAD, AND HAVE A LEVEL LOOP, TEXTURED LOOP, LEVEL CUT PILE, OR LEVEL CUT/ UNCUT PILE TEXTURE. THE MAXIMUM PILE THICKNESS SHALL BE 1/2 IN. EXPOSED EDGES OF CARPET SHALL BE FASTENED TO FLOOR SURFACES AND HAVE TRIM ALONG THE ENTIRE LENGTH OF THE EXPOSED EDGE.

GRATINGS: IF GRATINGS ARE LOCATED IN WALKING SURFACES, THEN THEY SHALL HAVE SPACES NO GREATER THAN 1/2 IN WIDE IN ONE DIRECTION. IF GRATINGS HAVE ELONGATED OPENINGS, THEN THEY SHALL BE PLACED SO THAT THE LONG DIMENSION IS PERPENDICULAR TO THE DOMINANT DIRECTION OF TRAVEL.

### 5. <u>DOORS:</u>

GENERAL: DOORS REQUIRED TO BE ACCESSIBLE BY 4.1 SHALL COMPLY WITH THE REQUIREMENTS OF 4.13.

CLEAR WIDTH: DOORWAYS SHALL HAVE A MINIMUM CLEAR OPENING OF 32 IN (815 MM) WITH THE DOOR OPEN 90 DEGREES, MEASURED BETWEEN THE FACE OF THE DOOR AND THE OPPOSITE STOP (SEE FIG. 24(A), (B), (C), AND (D)). OPENINGS MORE THAN 24 IN (610 MM) IN DEPTH SHALL COMPLY WITH 4.2.1 AND 4.3.3 (SEE FIG. 24(E)). EXCEPTION: DOORS NOT REQUIRING FULL USER PASSAGE, SUCH AS SHALLOW CLOSETS, MAY HAVE THE CLEAR OPENING REDUCED TO 20 IN (510 MM) MINIMUM.

MANEUVERING CLEARANCES AT DOORS: MINIMUM MANEUVERING CLEARANCES AT DOORS THAT ARE NOT AUTOMATIC OR POWER-ASSISTED SHALL BE AS SHOWN IN FIG. 25. THE FLOOR OR GROUND AREA WITHIN THE REQUIRED CLEARANCES SHALL BE LEVEL AND CLEAR, EXCEPTION: ENTRY DOORS TO ACUTE CARE HOSPITAL BEDROOMS FOR IN-PATIENTS SHALL BE EXEMPTED FROM THE REQUIREMENT FOR SPACE AT THE LATCH SIDE OF THE DOOR (SEE DIMENSION "X" IN FIG. 25) IF THE DOOR IS AT LEAST 44 IN (1120) MM) WIDE.

THRESHOLDS AT DOORWAYS: THRESHOLDS AT DOORWAYS SHALL NOT EXCEED 3/4 IN (19 MM) IN HEIGHT FOR EXTERIOR SLIDING DOORS OR 1/2 IN (13 MM) FOR OTHER TYPES OF DOORS. RAISED THRESHOLDS AND FLOOR LEVEL CHANGES AT ACCESSIBLE DOORWAYS SHALL BE BEVELED WITH A SLOPE NO GREATER THAN 1:2 (SEE 4.5.2).

**DOOR HARDWARE:** HANDLES, PULLS, LATCHES, LOCKS, AND OTHER OPERATING DEVICES ON ACCESSIBLE DOORS SHALL HAVE A SHAPE THAT IS INDICATED ON THE DOOR SCHEDULE

DOOR CLOSURES: IF A DOOR HAS A CLOSER, THEN THE SWEEP PERIOD OF THE CLOSER SHALL BE ADJUSTED SO THAT FROM AN OPEN POSITION OF 10 DEGREES, THE DOOR WILL TAKE AT LEAST 3 SECONDS TO MOVE TO A POINT 3 IN (75 MM) FROM THE LATCH, MEASURED TO THE LEADING EDGE OF THE DOOR.

**DOOR OPENING FORCE:** THE MAXIMUM FORCE FOR PUSHING OR PULLING OPEN A DOOR SHALL BE AS FOLLOWS: (1) FIRE DOORS SHALL HAVE THE MINIMUM OPENING FORCE ALLOWABLE BY THE APPROPRIATE ADMINISTRATIVE AUTHORITY. (2) OTHER DOORS. (A) EXTERIOR HINGED DOORS: (RESERVED). (B) INTERIOR HINGED DOORS: 5 LBF (22.2N) (C) SLIDING OR FOLDING DOORS: 5 LBF (22.2N) THESE FORCES DO NOT APPLY TO THE FORCE REQUIRED TO RETRACT LATCH BOLTS OR DISENGAGE OTHER DEVICES THAT MAY HOLD THE DOOR IN A CLOSED POSITION.

### 6. SIGNAGE:

ENTRANCES: ENTRANCES WHICH ARE NOT ACCESSIBLE SHALL HAVE DIRECTIONAL SIGNAGE WHICH INDICATES THE LOCATION OF THE NEAREST ACCESSIBLE ENTRANCE.

CHARACTER PROPORTION: LETTERS AND NUMBERS ON SIGNS SHALL HAVE A WIDTH-TO-HEIGHT RATIO BETWEEN 3:5 AND 1:1 AND A STROKE-WIDTH-TO-HEIGHT RATIO BETWEEN 1:5 AND 1:10.


CHARACTER HEIGHT: CHARACTERS AND NUMBERS ON SIGNS SHALL BE SIZED ACCORDING TO THE VIEWING DISTANCE FROM WHICH THEY ARE TO BE READ. THE MINIMUM HEIGHT IS MEASURED USING AN UPPER CASE X. LOWER CASE CHARACTERS ARE PERMITTED. HEIGHT ABOVE MINIMUM FINISHED FLOOR CHARACTER HEIGHT SUSPENDED OR PROJECTED 3"

RAISED AND BRAILLED CHARACTERS AND PICTORIAL SYMBOL SIGNS: LETTERS AND NUMERALS SHALL BE RAISED 1/32", UPPER CASE, SANS SERIF OR SIMPLE SERIF TYPE AND SHALL BE ACCOMPANIED WITH GRADE 2 BRAILLE. RAISED CHARACTERS SHALL BE AT LEAST 5/8" HIGH, BUT NO HIGHER THAN 2". PICTOGRAMS SHALL BE ACCOMPANIED BY THE EQUIVALENT VERBAL DESCRIPTION PLACED DIRECTLY BELOW THE PICTOGRAM. THE BORDER DIMENSION OF THE PICTOGRAM SHALL BE 6" MINIMUM IN HEIGHT.

FINISH AND CONTRAST: THE CHARACTERS AND BACKGROUND OF SIGNS SHALL BE EGGSHELL, MATTE, OR OTHER NON-GLARE FINISH. CHARACTERS AND SYMBOLS SHALL CONTRAST WITH THEIR BACKGROUND --EITHER LIGHT CHARACTERS ON A DARK BACKGROUND OR DARK CHARACTERS ON A LIGHT BACKGROUND.

MOUNTING LOCATION AND HEIGHT: WHERE PERMANENT IDENTIFICATION IS PROVIDED FOR ROOMS AND SPACES, SIGNS SHALL BE INSTALLED ON THE WALL ADJACENT TO THE LATCH SIDE OF THE DOOR. WHERE THERE IS NO WALL SPACE TO THE LATCH SIDE OF THE DOOR, INCLUDING AT DOUBLE LEAF DOORS, SIGNS SHALL BE PLACED ON THE NEAREST ADJACENT WALL. MOUNTING HEIGHT SHALL BE 60" ABOVE THE FINISH FLOOR TO THE CENTERLINE OF THE SIGN. MOUNTING LOCATION FOR SUCH SIGNAGE SHALL BE SO THAT A PERSON MAY APPROACH WITHIN 3" OF SIGNAGE WITHOUT ENCOUNTERING PROTRUDING OBJECTS OR STANDING WITHIN THE SWING OF A

SYMBOLS OF ACCESSIBILITY: FACILITIES AND ELEMENTS REQUIRED TO BE IDENTIFIED AS ACCESSIBLE SHALL USE THE INTERNATIONAL SYMBOL OF

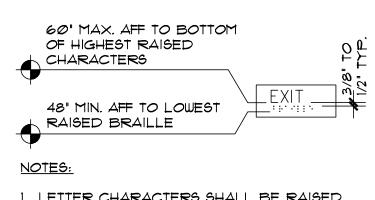

I. LETTER CHARACTERS SHALL BE RAISED 1/32" MIN. AND SHALL BE SANS SERIF UPPERCASE. MIN. HEIGHT 5/8" AND MAX. HEIGHT 2". HORIZONTAL FORMAT.


2. CHARACTERS AND THEIR BACKGROUND SHALL HAVE A NON-GLARE FINISH. CHARACTERS SHALL CONTRAST WITH THE BACKGROUND, EITHER LIGHT CHARACTERS ON DARK BACKGROUND OR DARK CHARACTERS ON LIGHT BACKGROUND.

3. PROVIDE CONTRACTED (GRADE 2) BRAILLE DIRECTLY UNDER THE TACTILE CHARACTERS. DOTS SHALL BE RAISED A MIN OF 1/40" ABOVE THE BACKGROUND AND ROUNDED OR DOMED. HORIZONTAL FORMAT


4. MOUNTING LOCATION FOR SUCH SIGNAGE SHALL BE SO THAT A PERSON MAY APPROACH WITHIN 3' OF SIGNAGE WITHOUT ENCOUNTERING PROTRUDING OBJECTS OR STANDING WITHIN THE SWING OF A DOOR.

### TYP. EXIT SIGN

N.T.S.

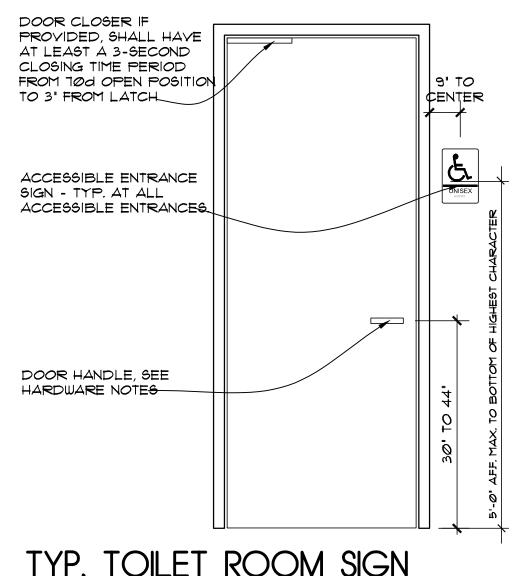

N.T.S.

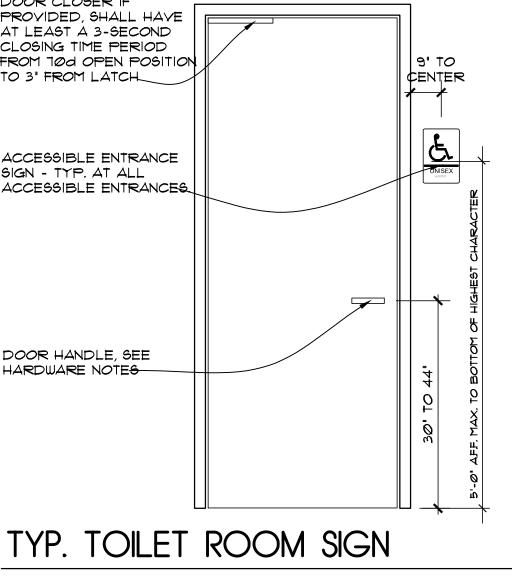

60" MAX. AFF TO BOTTOM OF HIGHEST RAISED CHARACTERS 48" MIN. AFF TO WOMEN LOWEST RAISED \_UNISEX BRAILLE NOTES:

1. PROVIDE THE UNIVERSAL "WHEELCHAIR" SYMBOLS

2. PICTORIAL SYMBOL (PICTOGRAMS) SHALL BE ACCOMPANIED BY THE VERBAL DESCRIPTION PLACED DIRECTLY BELOW. THE OUTSIDE DIMENSION OF THE PICTOGRAM FIELD SHALL BE A MIN. OF 6" HIGH.

3. LETTER CHARACTERS SHALL BE RAISED 1/32" MIN. AND SHALL BE SANS SERIF UPPERCASE. MIN. HEIGHT 5/8" AND MAX. HEIGHT 2". HORIZONTAL FORMAT.


4. CHARACTERS AND THEIR BACKGROUND SHALL HAVE A NON-GLARE FINISH. CHARACTERS SHALL CONTRAST WITH THE BACKGROUND, EITHER LIGHT CHARACTERS ON DARK BACKGROUND OR DARK CHARACTERS ON LIGHT BACKGROUND.

PROVIDE CONTRACTED (GRADE 2) BRAILLE DIRECTLY UNDER THE TACTILE CHARACTERS. DOTS SHALL BE RAISED A MIN OF 1/40" ABOVE THE BACKGROUND AND ROUNDED OR DOMED. HORIZONTAL FORMAT.

PERMANENT IDENTIFICATION PROVIDED FOR ROOMS AND SPACES SHALL BE INSTALLED ON THE WALL ADJACENT TO THE LATCH SIDE OF THE DOOR.

WHERE THERE IS NO WALL SPACE TO THE LATCH SIDE OF THE DOOR, INCLUDING AT DOUBLE-LEAF DOORS, SIGNS SHALL BE PLACED ON THE NEAREST ADJACENT WALL.


8. MOUNTING LOCATION FOR SUCH SIGNAGE SHALL BE SO THAT A PERSON MAY APPROACH WITHIN 3' OF SIGNAGE WITHOUT ENCOUNTERING PROTRUDING OBJECTS OR STANDING WITHIN THE SWING OF A DOOR.

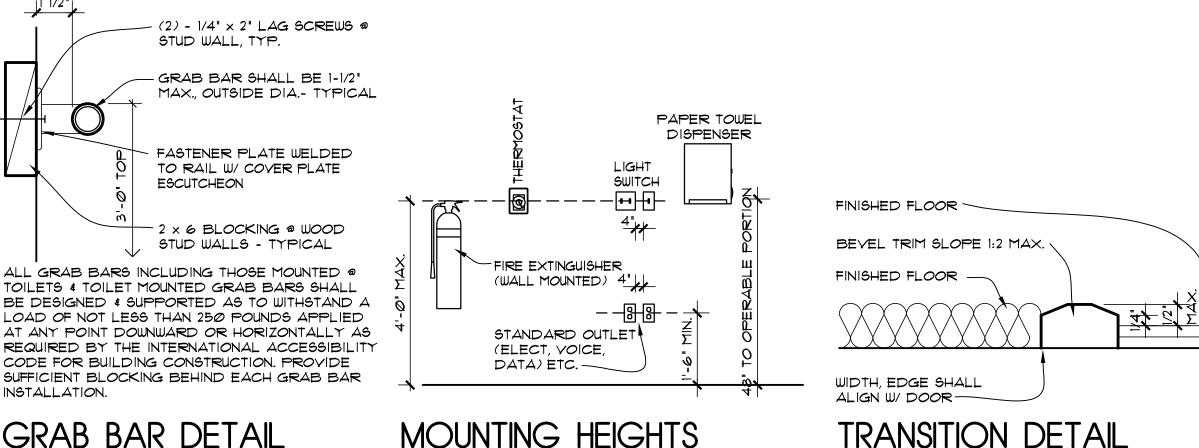

GRAB BAR DETAIL


TRANSITION DETAIL

NTS

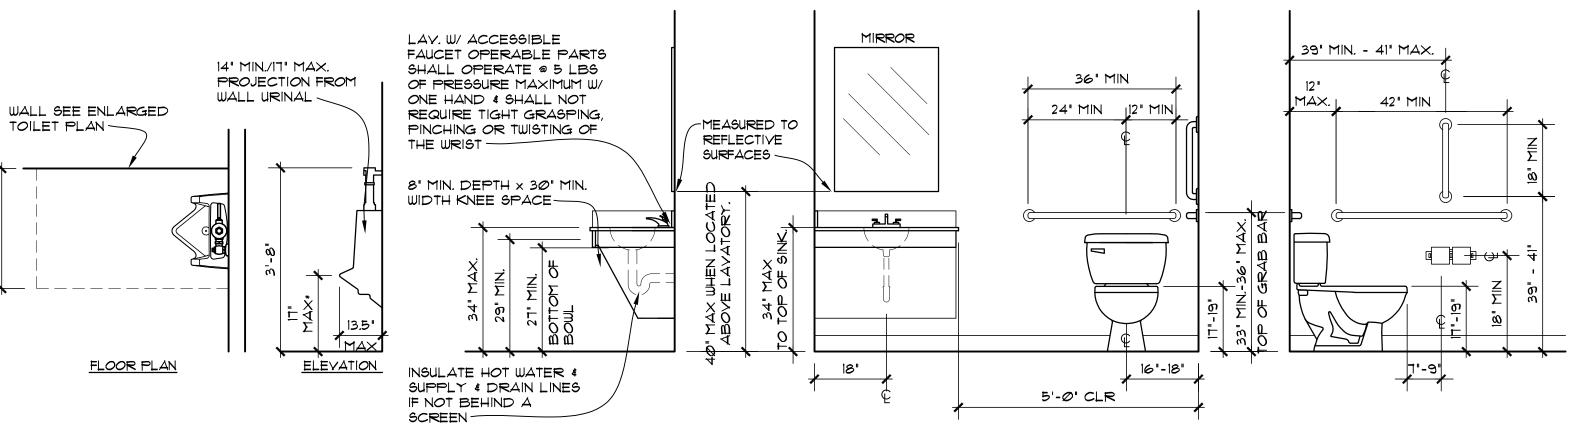

### MOUNTING HEIGHTS

N.T.S.

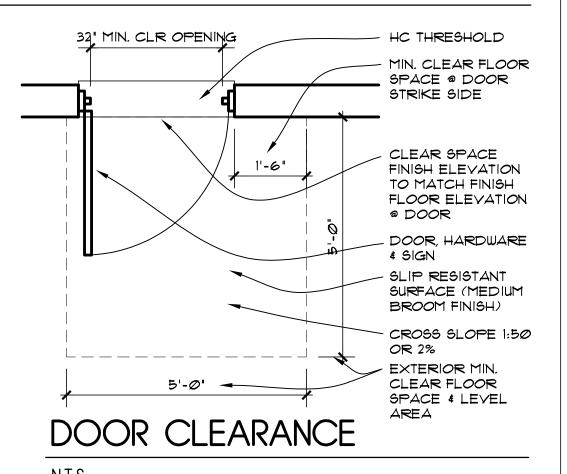



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DATE: FEBRUARY 14, 2023

REVISION DATES:


PROJECT:

VISTA COMMUNITY CHURCH 5626 FRANTZ RD. DUBLIN, OHIO 43017

PROJECT NUMBER: CAI202175

SHEET TITLE:

ACCESSIBILITY NOTES/ DETAILS

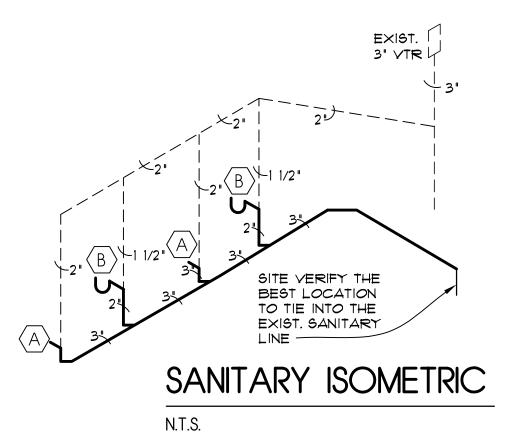

### PLUMBING NOTES

- ALL DOMESTIC WATER PIPING (INTERIOR) SHALL BE HARD DRAWN COPPER TYPE "L" ABOVE GRADE, CPVC OR PEX & SOFT DRAWN COPPER TYPE "K" W/ BRAZED JOINTS OR RIGID PLASTIC BELOW GRADE.
- INSULATE ALL DOMESTIC (INTERIOR) WATER PIPING, HOT & COLD, W/ 1/2" FIBERGLASS INSULATION W/ YAPOR BARRIER. ALL WATER LINES SHALL RUN ABOVE THE SUSP. ACOUSTICAL CEILING.
- 3. SANITARY WASTE & VENT PIPING SHALL BE PVC PIPING ALL AS APPROVED BY THE LOCAL AUTHORITY. INSTALL & TEST ALL SANITARY WASTE & VENT PIPING IN ACCORDANCE W/ ALL LOCAL, STATE & FEDERAL CODES.
- 4. COMPLETELY FLUSH & STERILIZE ALL DOMESTIC WATER PIPING PER AWWA RECOMMENDATIONS & PER THE LOCAL COUNTY HEALTH DEPARTMENT REQUIREMENTS. PROVIDE & PAY FOR ALL APPLICABLE TESTS, PERMITS & FEES. DOMESTIC WATER PIPING SHALL BE PRESSURE TESTED TO 100 PSIG FOR SIX (6) HOURS W/ NO DROP.
- 5. THE CONTRACTOR SHALL BE RESPONSIBLE FOR OBTAINING & PAYING FOR ALL FEES, PERMITS & INSPECTIONS REQUIRED FOR THE PERFORMANCE OF
- 6. IT IS THE INTENT THAT THE CONTRACTOR PROVIDE COMPLETE SANITARY \$ WATER PIPING SYSTEMS W/ ALL NECESSARY APPURTENANCES IN CONFORMANCE W/ ALL APPLICABLE ORDINANCES. THIS CONTRACTOR SHALL BE RESPONSIBLE FOR PROVIDING SUCH SYSTEM WHETHER ALL REQUIRED WORK IS INDICATED IN THE CONTRACT DOCUMENTS OR NOT.
- DRAWINGS ARE SCHEMATIC IN NATURE & CONTRACTOR IS RESPONSIBLE FOR FIELD COORDINATING & ROUTING OF ALL PIPING ETC. W/ RESPECT TO NEW CONSTRUCTION, ATTIC TRUSSES, OTHER TRADES, ETC. COORD. W/ GENERAL CONTRACTOR FOR PROVIDING & INSTALLING ALL OFFSETS, JOGS, TRANSITIONS, CORE DRILLS, WALL CUTS, LENTILS & OTHER NECESSARY FITTINGS TO INSTALL WORK, WORK WHICH HAS BEEN INSTALLED & HAS NOT BEEN COORDINATED W/ OTHER TRADES & HAS TO BE RELOCATED SHALL BE DONE SO AT THE EXPENSE OF THIS CONTRACTOR.
- 8. CONTRACTOR SHALL OBTAIN A COMPLETE SET OF PLANS & BE FAMILIAR W/ THE ENTIRE PROJECT IN ORDER TO UNDERSTAND THE COMPLETE SCOPE OF THE PROJECT.
- 9. FLOOR DRAINS, DIRECTLY CONNECTED, SHALL HAVE A PERMANENT WATER TRAP SEAL
- 10. SOIL & WASTE PIPE SHALL SLOPE 2% MINIMUM, UNLESS OTHERWISE NOTED OR REQUIRED BY CODE.
- 11. ALL DRAIN & SUPPLY LINES SHALL BE KEPT TIGHT TO THE UNDERSIDE OF EQUIPMENT & SECURED IN PLACE.
- 12. ALL EXPOSED PLUMBING LINES UNDER THE SINK SHALL BE PROTECTED BY INSULATION & COMPLY W/ ANSI
- 13. CONTRACTOR SHALL VERIFY THE LOCATION OF THE EXIST. SANITARY LINES INSIDE THE BUILDING.
- 14. ALL VENTS SHALL BE 3", THRU THE ROOF, REUSE EXIST. WERE POSSIBLE, UNLESS OTHERWISE NOTED.
- 15. ALL PLUMBING FIXTURE VENTS TO TERMINATE A MINIMUM OF 12 INCHES FROM ANY VERTICAL SURFACE & 10 FEET FROM ANY OUTSIDE AIR INTAKE.
- 16. AT LEAST (1) SOIL OR WASTE STACK SHALL EXTEND FULL SIZE THROUGH THE REAR OF BUILDING & SHALL BE AS DIRECT AS POSSIBLE & FREE FROM SHARP ANGLES & TURNS
- 17. ALL CLEAN OUTS SHALL BE INSTALLED WHERE READILY ACCESSIBLE. THE CONTRACTOR SHALL COORDINATE ALL CLEAN OUT LOCATIONS W/ EQUIPMENT, CABINETS, ETC. PRIOR TO ANY INSTALLATION.
- 18. CLEAN OUTS SHALL BE INSTALLED @ EACH CHANGE OF DIRECTION OF THE BUILDING DRAIN OR HORIZONTAL WASTE OR SOILS LINE GREATER THAN A 45 DEGREE PER OPC 108.3.3

- ALL VALVES, TRAP PRIMERS, SHOCK ARRESTORS OR OTHER EQUIPMENT SHOWN IN WALLS OR ABOVE NON-ACCESSIBLE CEILING SHALL BE INSTALLED BEHIND AN ACCESS PANEL.
- 20. INSTALLATION SHALL CONFORM TO THE ENERGY CODE FOR NEW COMMERCIAL BUILDINGS.
- 21. THE INSTALLATION & MATERIALS FOR THE PLUMBING SYSTEM SHALL COMPLY W/ THE OHIO PLUMBING CODE
- 22. PRIOR TO COMMENCING WORK ON THIS PROJECT, CONTRACTOR SHALL VERIFY DEPTH, SIZE, LOCATION & CONDITION OF ALL EXISTING UTILITIES IN FIELD BEFORE STARTING WORK. SHOULD CONDITIONS EXIST OTHER THAN THOSE INDICATED WHICH WOULD CAUSE THE DESIGN TO BE ALTERED, CONTRACTOR SHALL NOTIFY OWNER IMMEDIATELY.
- CONTRACTOR SHALL COORDINATE INSTALLATION OF PLUMBING WORK W/ ALL OTHER TRADES SO AS TO AVOID UNNECESSARY DELAY OR INTERFERENCES. CONTRACTOR TO REVIEW ARCHITECTURAL & EQUIPMENT
- 24. ALL PLUMBING WORK & MATERIALS SHALL BE INSTALLED IN ACCORDANCE W/ ALL APPLICABLE STATE & LOCAL ORDINANCES & REGULATIONS HAVING JURISDICTION. CONTRACTOR SHALL OBTAIN ALL APPROVALS REQUIRED FROM REGULATING AGENCIES BEFORE STARTING WORK. ALL PLUMBING WORK & MATERIALS SHALL MEET THE REQUIREMENTS OF THE LATEST EDITIONS OF THE LOCAL PLUMBING CODE, UNLESS OTHERWISE REQUIRED BY THE DEPARTMENT OF BUILDING & SAFETY. OBTAIN & PAY FOR ALL PERMITS, FEES & INSPECTIONS REQUIRED BY GOVERNING AUTHORITIES. ALL PIPING TO BE CONCEALED, UNLESS NOTED OTHERWISE.
- 25. THE EQUIPMENT ROUGH-INS AS SHOWN ARE BASED UPON AVAILABLE INFORMATION. HOWEVER, IN SOME INSTANCES, THE OWNER OR SUPPLIER MAY SUBSTITUTE OR THE EQUIPMENT ITEM MAY YARY FROM WHAT IS SHOWN, THEREFORE, THE CONTRACTOR SHALL VERIFY ALL CRITICAL DIMENSIONS W/ THE OWNER PRIOR TO CONSTRUCTION. FAILURE OF THE CONTRACTOR TO VERIFY THESE DIMENSIONS SHALL PLACE THE RESPONSIBILITY FOR ANY SUBSEQUENT RELOCATION DIRECTLY ON THE CONTRACTOR.
- INSTALL SHUTOFF VALVES ON ALL HOT & COLD WATER LINES TO FIXTURE OR APPLIANCE.
- 27. ALL VALVES, UNIONS, ETC. TO BE SAME SIZE AS PIPE UNLESS OTHERWISE INDICATED ON DRAWINGS.
- 28. THERE SHALL BE PRESSURE TYPE VACUUM BREAKERS INSTALLED ON THE MOP SINK & WATER HEATER
- 29. VERIFY THE EXIST. BACK FLOW PREVENTOR FOR THE BUILDING SERVICE
- YERIFY THE INCOMING DOMESTIC WATER LINE SIZE & PRESSURE 31. THE PLUMBING CONTRACTOR HAS THE RIGHT TO SUBSTITUTE THE
- MANUFACTURER OF THE EQUIPMENT OR FIXTURES AS LONG AS THE EQUIPMENT OR FIXTURES MEETS OR EXCEEDS THE DESIGN REQUIREMENTS
- 32. THE PLUMBING CONTRACTOR HAS THE OPTION OF DESIGNING A "WET-VENT" DRAIN SYSTEM FOR THIS PROJECT.
- 33. PROVIDE TEMPERATURE CONTROL VALVES @ ALL HAND SINKS, MAINTAIN A MAX. TEMPERATURE OF 110 DEGREES, MANUFACTURE 'WATTS' MODEL USG-B OR EQUAL. (2) SINKS CAN RUN OFF OF (1) TEMPERING VALVE, PROVIDE EASY ACCESS
- 34. PROVIDE TEMPERATURE CONTROL VALVES @ ALL SHOWERS SHALL BE AS SPEC'D IN THE PLUMBING SCHEDULE OR EQUAL. VALVES SHALL MEET W/ THE ASSE 1070 STANDARD.
- 35. THE PLUMBING DESIGN OR LAYOUT CAN BE ADJUSTED BY THE PLUMBER DUE TO EXISTING CONDITIONS OR EASE OF CONSTRUCTION.


		PLUMBING SCHEDULE						
SYMBOL	FIXTURE	DESCRIPTION	TRAP	VENT	DRAIN	DCW	DHW	REMARKS
$\langle A \rangle$	ADA WATER CLOSET	AMERICAN STANDARD "MADERA" 1.6/FV ELONGATED BOWL, 1.6 GALLON, SEAT: OLSONITE *95 OR CHURCH *9500C OPEN FRONT SEAT LESS COVER OR EQUAL.	3"	2"	3'	1 1/2"		1
		AMERICAN STANDARD 'TROPIC OVAL' *0405,004EC W/				1/2"	1/2"	
<b>(B)</b>	LAVATORY (DROP IN)	TROPIC FAUCETS TWO HANDLE GOOSENECK FAUCET *1038.801 W/ GRID DRAIN OR APPROVED EQUAL	1 1/2"	1 1/4"	2"	TO MIXING YALVE 1/2" TW TO SINKS		2
(C)	EXIST. WATER CLOSET	EXIST. WATER CLOSET, VERIFY IN GOOD CONDITION & GOOD WORKING ORDER FOR REUSE						
D	EXIST. URINAL	EXIST. URINAL, VERIFY IN GOOD CONDITION & GOOD WORKING ORDER FOR REUSE						
(E)	EXIST. LAY.	EXIST. LAV., VERIFY IN GOOD CONDITION & GOOD WORKING ORDER FOR REUSE. VERIFY THE LEVER HANDLE CONTROLS ARE IN GOOD WORKING ORDER. VERIFY COUNTER IS NO MORE THEN 34" HIGH FOR ACCESSIBILITY				YERIF MIXINO YALY TW TO	3	
F	EXIST. MOP SINK	EXIST. MOP SINK, VERIFY IN GOOD CONDITION & GOOD WORKING ORDER FOR REUSE. VERIFY THERE IS A PRESSURE TYPE VACUUM BREAK INSTALLED ON THE UNIT						
(G)	EXIST. WATER COOLER	EXIST. WATER COOLER, VERIFY IN GOOD CONDITION & GOOD WORKING ORDER FOR REUSE. VERIFY HEIGHT IS NO MORE THAN 36" AFF						
H	EXIST. WATER HEATER	EXIST. WATER HEATER, VERIFY IN GOOD CONDITION & GOOD WORKING ORDER FOR REUSE.						
						1/2"	1/2"	2
	SINGLE BOWL SINK	ELKAY, SINGLE BOWL SINK. MODEL BCRID W/ ELKAY DECK MOUNT 4" CENTER GOOSENECK W/ LEVERED HANDLES	1 1/2"	1 1/4"	2'	TO MI VALV TW TO		MOUNT TOP AS INDICATED

### HIXTURES MAY BE SUBSTITUTED W/ OWNER APPROVAL.


- \*\* ALL PLUMBING FIXTURES SHALL BE INSTALLED IN ACCORDANCE W/ MANUFACTURERS SPEC.'S.
- REMARKS: 1. 1 1/4" CHROME PLATED CAST BRASS TAILPIECE & TRAP W/ CLEANOUT PLUG, CHROME PLATED COPPER SUPPLIES W/ STOPS, CHROME PLATED BRASS ESCUTCHEON PLATES AT WALL PENETRATIONS.
  - 2. INSULATE TRAP & SUPPLIES PER ANSI GUIDELINES. MOUNT TOP OF FRONT RIM AT 34" A.F.F.

### PLUMBING ACCESSIBILITY NOTES

- 1. TOILET FLUSH CONTROLS SHALL BE OPERABLE W/ ONE HAND & SHALL NOT REQUIRE TIGHT GRASPING, PINCHING, OR TWISTING OF THE WRIST. CONTROLS FOR THE FLUSH VALVES SHALL BE MOUNTED NO MORE THAN 44" ABOVE THE FLOOR, THE FORCE REQUIRED TO ACTIVATE CONTROLS SHALL BE NO GREATER THAN 5 LBS/FT.
- 2. HOT WATER & DRAIN PIPES UNDER LAVATORIES SHALL BE INSULATED OR OTHERWISE COVERED. THERE SHALL BE NO SHARP OR ABRASIVE SURFACE UNDER LAVATORIES.
- 3. FAUCET CONTROLS & OPERATING MECHANISMS SHALL BE OPERABLE W/ ONE HAND & SHALL NOT REQUIRE TIGHT GRASPING, PINCHING OR TWISTING OF THE WRIST. THE FORCE REQUIRED TO ACTIVATE THE CONTROLS SHALL BE NO GREATER THAN 5 LBS/FT. LEVER PUSH-TYPE & ELECTRONICALLY CONTROLLED MECHANISMS ARE EXAMPLES OF ACCEPTABLE DESIGN, SELF CLOSING VALVES ARE ALLOWED IF THE FAUCETS REMAIN OPEN FOR AT LEAST 10 SECONDS.
- 4. FLUSH HANDLES SHALL BE ON THE WIDE SIDE OF THE TOILET ROOM.

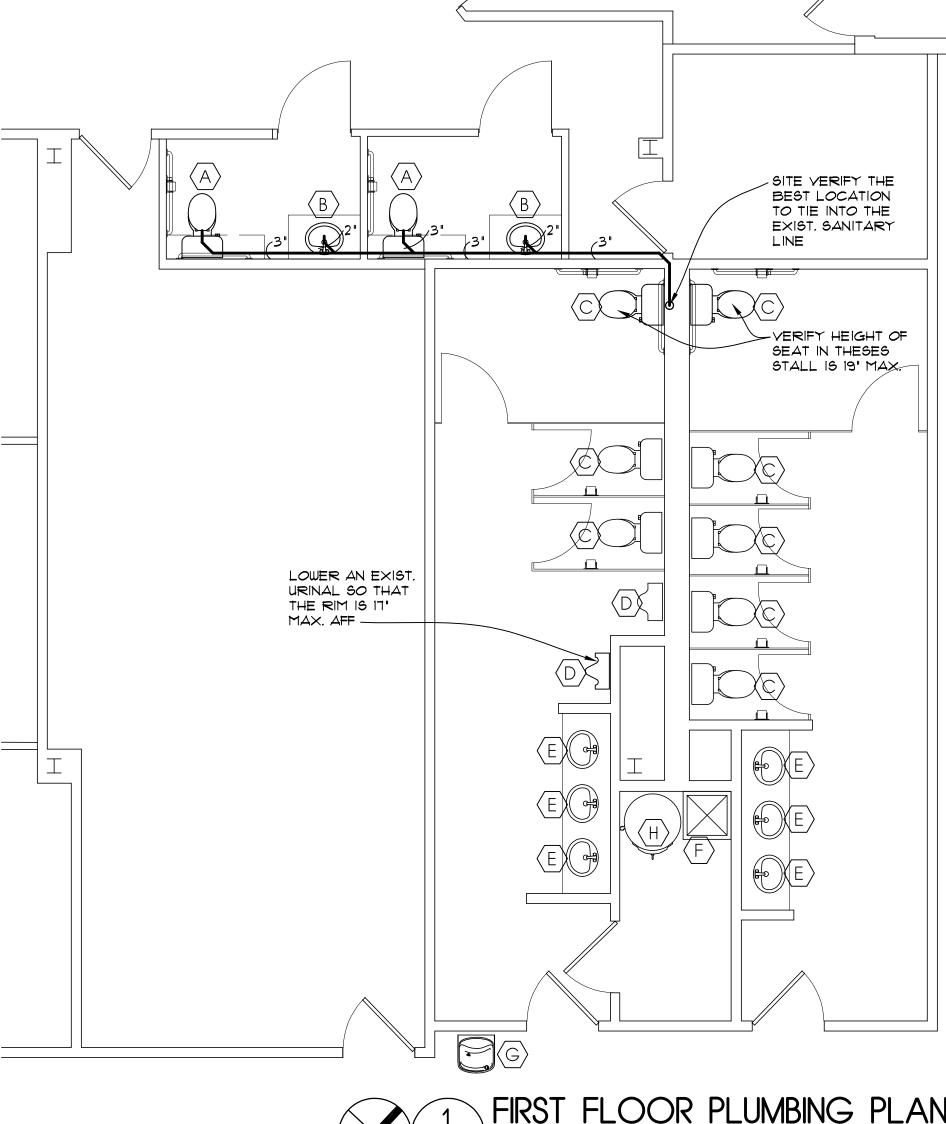



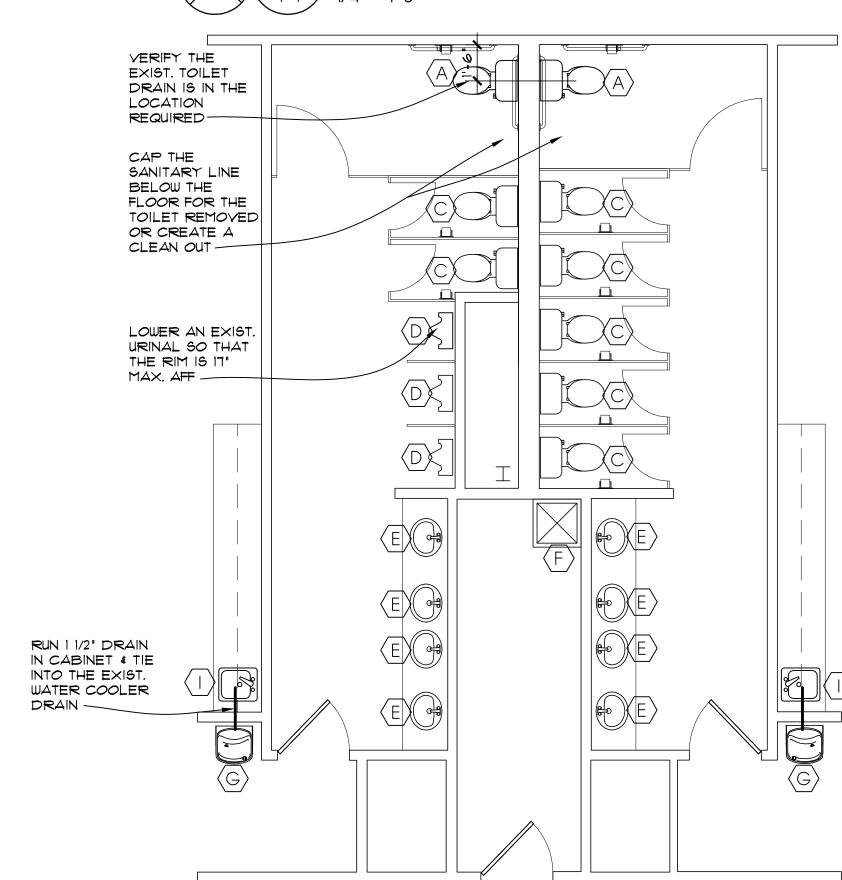





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FEBRUARY 14, 2023

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VISTA COMMUNITY CHURCH 5626 FRANTZ RD.

PROJECT NUMBER: CAI202175

DUBLIN, OHIO 43017

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PLUMBING PLANS/NOTES